## TAX MAP

SCALE: 1"=1000'

## STORMWATER MANAGEMENT AND SEDIMENT AND EROSION CONTROL PLANS

SOUTH BEACH RESTORATION

### BENCHMARK NOTE

VERTICAL DATUM IS REFERENCED TO NAVD 88

IRON BAR W/ CAP SET N: 490375.65 E: 1483286.61

## SANDY POINT STATE PARK

1100 E COLLEGE PKY ANNAPOLIS 21409-0000 TAX ID: 03-000-29043249 TAX MAP 41, GRID 21, PARCEL 98 THIRD DISTRICT ~ ANNE ARUNDEL COUNTY ~ ZONED OS

# AS-BUILT CERTIFICATION FACILITIES BEING CERTIFIED (LIST EACH INDIVIDUALLY JSING FACILITY ID NUMBER AND/OR DESCRIPTION):

#### GENERAL NOTES

1. OWNER STATE OF MARYLAND C/O LAND & PROPERTY MGNT E-3 580 TAYLOR AVE, TAWES BLD ANNAPOLIS MD 21401-2352

BAY ENGINEERING, INC. 2661 RIVA ROAD, BUILDING 800 ANNAPOLIS, MARYLAND 21401 C/O TERRY SCHUMAN TSCHUMAN@BAYENGINEERING.COM

2. THE PROPERTY IS SHOWN ON: TAX MAP 41, GRID 21, PARCEL 98.

3. THE TAX ACCOUNT INFORMATION IS: 03-000-29043249

4. THE EXISTING ZONING OF THE SITE IS OS - OPEN SPACE

5. THE SITE ADDRESS IS 1100 E COLLEGE PKY ANNAPOLIS 21409-0000

6. THE EXISTING USE OF THE SITE IS A STATE PARK

7. THE STATE PARK HAS AN AREA OF 786 AC.±.

8. THE SITE IS IS LOCATED WITHIN THE CHESAPEAKE BAY CRITICAL AREA.

9. THE EXISTING TOPOGRAPHY AND FEATURES SHOWN HEREON WERE TAKEN FROM A SURVEY PROVIDED BY THE DEPARTMENT OF NATURAL RESOURCES DATED MARCH 2021, AND SUPPLEMENTED BY BAY ENGINEERING, INC. IN THE PROPOSED WORK AREAS ONLY IN FEBRUARY, 2023. THE REMAINING SITE AREA, EXISTING UTILITIES AND FEATURES OF SURROUNDING PROPERTIES AND ROADS WERE TAKEN FROM A COMBINATION OF SURVEY DATA AND EXISTING COUNTY PUBLIC DRAWINGS. THE ELEVATIONS SHOWN HEREON ARE BASED ON GPS OBSERVATIONS USING ANNE ARUNDEL COUNTY CONTROL STATION (SEE BENCHMARK INFORMATION THIS SHEET). ALL HORIZONTAL DATUM IS REFERENCED TO MD STATE PLANE (NAD 83/91) AND THE VERTICAL DATUM IS REFERENCED TO NAVD 88.

10. THE LOCATION OF ALL UNDERGROUND UTILITIES ARE APPROXIMATE. ALL LOCATIONS AND SIZES ARE BASED ON ABOVE GROUND STRUCTURES THAT WERE VISIBLE AND ACCESSIBLE IN THE FIELD, AND RECORD MAPS AVAILABLE AT THE TIME OF THE SURVEY. AVAILABLE AS-BUILT PLANS AND UTILITY MARK OUT DOES NOT ENSURE MAPPING OF ALL UNDERGROUND UTILITIES AND STRUCTURES. BEFORE ANY EXCAVATION IS TO BEGIN, ALL UNDERGROUND UTILITIES SHOULD BE VERIFIED AS TO THEIR LOCATION, SIZE AND TYPE BY THE PROPER UTILITY COMPANIES.

11. THE PROPERTY SHOWN HEREON IS LOCATED IN BOTH FLOOD HAZARD ZONES AE EL. 5 (BASED FLOOD ELEVATIONS) AND VE EL. 7 (COSTAL FLOOD ZONE WITH VELOCITY HAZARD (WAVE ACTION)) AS DELINEATED ON THE FLOOD INSURANCE RATE MAP #24003C0195F FEBRUARY 18, 2015 FOR ANNE ARUNDEL COUNTY, MARYLAND AND DISTRIBUTED BY THE FEDERAL EMERGENCY MANAGEMENT AGENCY.

12. THE SITE UTILITIES ARE NOT PUBLIC IN AREA AND ARE NOT SHOWN IN THE ANNE ARUNDEL COUNTRY ENGINEERING RECORD DRAWING AND MONUMENTS MAPS.

13. THE CONTRACTOR SHALL BE RESPONSIBLE FOR REPLACING ANY FENCE, DRIVEWAYS, ETC. DAMAGED OR REMOVED BY HIM DURING CONSTRUCTION. ALL DISTURBED AREAS OUTSIDE OF THE RIGHT-OF-WAY LINES SHALL BE RETURNED TO THEIR ORIGINAL CONDITION UNLESS OTHERWISE INDICATED OR SPECIFIED.

14. ALL CONSTRUCTION METHODS AND MATERIAL SHALL BE IN ACCORDANCE WITH THE LATEST STATE OF MARYLAND DETAILS AND SPECIFICATIONS FOR CONSTRUCTION OF STORM DRAINS, WATER, SEWER, AND ROADS.

15. IT SHALL BE DISTINCTLY UNDERSTOOD THAT FAILURE TO MENTION SPECIFICALLY ANY WORK THAT WOULD NATURALLY BE REQUIRED TO COMPLETE THE PROJECT SHALL NOT RELIEVE THE CONTRACTOR OF HIS RESPONSIBILITY TO PERFORM SUCH

16. THESE DRAWINGS DO NOT INCLUDE THE NECESSARY COMPONENTS FOR CONSTRUCTION SAFETY. ALL CONSTRUCTION MUST BE DONE IN COMPLIANCE WITH THE MOST CURRENT VERSION OF OSHA STANDARDS AND/OR REGULATIONS.

17. IT SHALL BE THE RESPONSIBILITY OF THE CONTRACTOR TO NOTIFY THE ENGINEER OF ANY DEVIATION TO THIS PLAN PRIOR TO ANY CHANGE BEING MADE. ANY CHANGE IN THIS PLAN WITHOUT THE WRITTEN AUTHORIZATION FOR SAID CHANGE FROM THE ENGINEER SHALL BE THE RESPONSIBILITY OF THE CONTRACTOR OR SUB-CONTRACTOR. SAID CHANGES MAY WARRANT

18. THE CONTRACTOR SHALL NOTE THAT IN THE CASE OF A DISCREPANCY BETWEEN THE SCALED AND THE FIGURED

19. THE CONTRACTOR SHALL BE RESPONSIBLE FOR THE COORDINATION OF HIS CONSTRUCTION WITH THE CONSTRUCTION BY OTHER CONTRACTORS.

20. ALL UTILITY POLES SHALL BE BRACED WHEN NECESSARY AT THE CONTRACTOR'S EXPENSE. THE UTILITY POLES SHALL BE RELOCATED AT THE OWNERS EXPENSE ONLY IN CASES WHERE THEY WILL INTERFERE WITH CONSTRUCTION.

21. THE PERMITTEE (OR HIS REPRESENTATIVE) SHALL NOTIFY THE WATER AND SCIENCE ADMINISTRATION (WSA) @ 410-631-3150 AT LEAST SEVEN (7) DAYS BEFORE COMMENCING ANY LAND DISTURBING ACTIVITY AND SHALL BE REQUIRED TO HOLD A PRE-CONSTRUCTION MEETING BETWEEN PROJECT REPRESENTATIVES AND A REPRESENTATIVE OF WSA.

22. ALL WATER AND SEWER UTILITIES SHALL BE SEPARATED BY A MINIMUM OF 10 FEET OR AS DIRECTED BY THE ENGINEER.

24. THE CONTRACTOR SHALL NOTIFY BGE @ 410-234-5691, FIVE (5) WORKING DAYS BEFORE STARTING WORK SHOWN ON THESE

25. THE CONTRACTOR SHALL NOTIFY THE VERIZON TELEPHONE COMPANY @ 301-393-3648, FIVE (5) WORKING DAYS BEFORE STARTING WORK SHOWN ON THESE DRAWINGS.

26. PIPE ELEVATIONS REFER TO INVERTS UNLESS OTHERWISE SPECIFIED.

MDE, ANNE ARUNDEL COUNTY, AND /OR SHA REVIEW AND APPROVAL

DIMENSIONS SHOWN ON THESE PLANS, THE FIGURED DIMENSION SHALL GOVERN.

28. THE CONTRACTOR SHALL SAWCUT ALL JOINTS WHERE THE PROPOSED PAVEMENT MEETS THE EXISTING PAVEMENT.

29. IN PREPARATION OF THESE PLANS THE BEST AVAILABLE RECORDS, DEEDS, MAPS, SURVEYS AND AERIAL TOPOGRAPHY WERE USED.

## SEQUENCE OF CONSTRUCTION

SEC (REFER TO SHEETS C7 & C8)

2. INSTALL STABILIZED CONSTRUCTION ENTRANCES IN ACCORDANCE WITH THE PLANS. ..... 1 DAY

- 5. UPON THE INSPECTOR'S APPROVAL BEGIN DEMOLITION OF PAVEMENT PER SHEET L-1, HAULING ALL DEBRIS TO AN APPROVED SITI
- BEGIN ROUGH GRADING THE SITE. ALL SITE IMPROVEMENTS MAY BEGIN. INCLUDING BUT NOT LIMITED TO UTILITIES. EXISTING UTILITIES AND LAYOUT. THE EXISTING STORM DRAIN SHALL REMAIN FUNCTIONAL DURING THE CONSTRUCTION. ..... 1 MONTH
- USING SAME DAY STABILIZATION. THE CONTRACTOR SHALL CONSTRUCT THE ELEVATED BEACH ACCESS WALKWAYS. .... 1 WEEK CONSTRUCT VEHICULAR ROUNDABOUT AT MARKET CIRCLE, THE CRUSHED GRAVEL TRAILS, CLAMSHELL PATHS, AND STAMPED
- 9. FINE GRADE AND INSTALL SEEDING, SOD, AND LANDSCAPING. ONCE ANY CONTRIBUTING DRAINAGE AREA IS FULLY STABILIZED,
- INSTALLATION OF STORMWATER MANAGEMENT FACILITIES MAY COMMENCE. ..... 3 WEEKS 10. SUBJECT TO THE WSA INSPECTOR'S APPROVAL, REMOVE ANY REMAINING SEDIMENT CONTROL MEASURES. PERFORM A FINAL CLEANUP AND MAINTENANCE OF VEGETATION AS NECESSARY TO ENSURE ESTABLISHED GROWTH OF ALL SEEDED AREAS. A FINAL SITE SURVEY AND AS-BUILT SUBMISSION PACKAGE IS REQUIRED AND APPROVAL NEEDED BY THE WSA PRIOR TO PROJECT

FOLLOWING INITIAL SOIL DISTURBANCE OR RE-DISTURBANCE, PERMANENT OR TEMPORARY STABILIZATION SHALL BE COMPLETED A. THREE (3) CALENDAR DAYS AS TO SURFACE OF ALL PERIMETER CONTROLS, DIKES, SWALES, DITCHES, PERIMETER SLOPES, B. SEVEN (7) DAYS AS TO ALL OTHER DISTURBED OR GRADED AREAS ON THE PROJECT SITE NOT UNDER ACTIVE GRADING. C. ALL DISTURBED AREAS SHALL BE TEMPORARILY OR PERMANENTLY STABILIZED WITH VEGETATION.

## **OUTFALL STATEMENT**

PARK SITE. THERE ARE NO EXISTING STORMWATER MANAGEMENT FACILTIES ONSITE AND ALL RUNOFF DRAINS DIRECTLY TO THE CHESAPEAKE BAY OR MEZICK POND WHICH IS TIDALLY AFFECTED BY THE BAY. THEREFORE THE SITE HAS BEEN REVIEWED AS HAVING ONE LINE OF INVESTIGATION FOR DRAINAGE AREA PURPOSES. THE NET INCREASE IN IMPERVIOUS AREA ONSITE IS OFFSET BY THE NON-ROOFTOP DISCONNECT CREDIT THAT THE SITE CAN TAKE DUE TO THE SANDY SOILS, AND THE ADDITIONAL VEGETATED AREAS THAT ARE BEING ADDED WHICH WILI

A FIELD INVESTIGATION OF THE SITE OUTFALLS WAS PERFORMED BY A REPRESENTATIVE OF BAY ENGINEERING, INC. NO SIGNS OF EROSION OR CAPACITY ISSUES WERE VISIBLE. AS A RESULT, IT IS CONCLUDED THAT THE PROPOSED DEVELOPMENT WILL NOT HAVE AN ADVERSE IMPACT ON THE RECEIVING STORM DRAIN OR WATERWAYS.

#### OWNER / DEVELOPER'S CERTIFICATION

I / WE HEREBY CERTIFY THAT ALL CLEARING, GRADING, CONSTRUCTION, AND/OR DEVELOPMENT WILL CONSTRUCTION PROJECT WILL HAVE A CERTIFICATE OF ATTENDANCE AT A MARYLAND DEPARTMENT PERIODIC ON-SITE EVALUATION BY APPROPRIATE INSPECTION AND ENFORCEMENT AUTHORITY OR THE STATE OF MARYLAND, DEPARTMENT OF THE ENVIRONMENT. I/WE HEREBY CERTIFY THAT

RESPONSIBLE PERSONNEL CERTIFICATION NO. PRINTED NAME AND TITLE

#### DRAWING INDEX

## COVER PLAN

- OVERALL SITE PLAN **EXISTING CONDITIONS PLAN EXISTING CONDITIONS PLAN**
- SITE GRADING PLAN SITE GRADING PLAN
- SEDIMENT CONTROL PLAN SEDIMENT CONTROL PLAN **DETAILS & SPECIFICATIONS**
- SEDIMENT CONTROL SPECIFICATIONS

PROPOSED DRAINAGE AREA PLAN


- SWM DETAILS & SPECIFICATIONS EXISTING DRAINAGE AREA PLAN
- DEMOLITION PLAN FURNITURE & MATERIALS PLAN
- MARKET CIRCLE MATERIALS PLAN FURNITURE DETAILS
- FURNITURE & PAVING DETAILS PAVING DETAILS

PLANTING DETAILS

- TREE PLANTING PLAN PLANTING ENLARGEMENT SPECIAL AREA
- PLANTING ENLARGEMENT SPECIAL AREA PLANTING ENLARGEMENT SPECIAL AREA
- RESTORATION PLANTINGS AND SIGNAGE PLAN RESTORATION PLANTINGS AND SOIL AMENDMENT PLAN

RESTORATION PLANTINGS AND SOIL AMENDMENT PLAN

- DETAILS AND MAINTENANCE PLAN
- FOUNDATION PLANS FRAMING PLANS AND SECTION
- TYPICAL DETAILS AND GENERAL NOTES

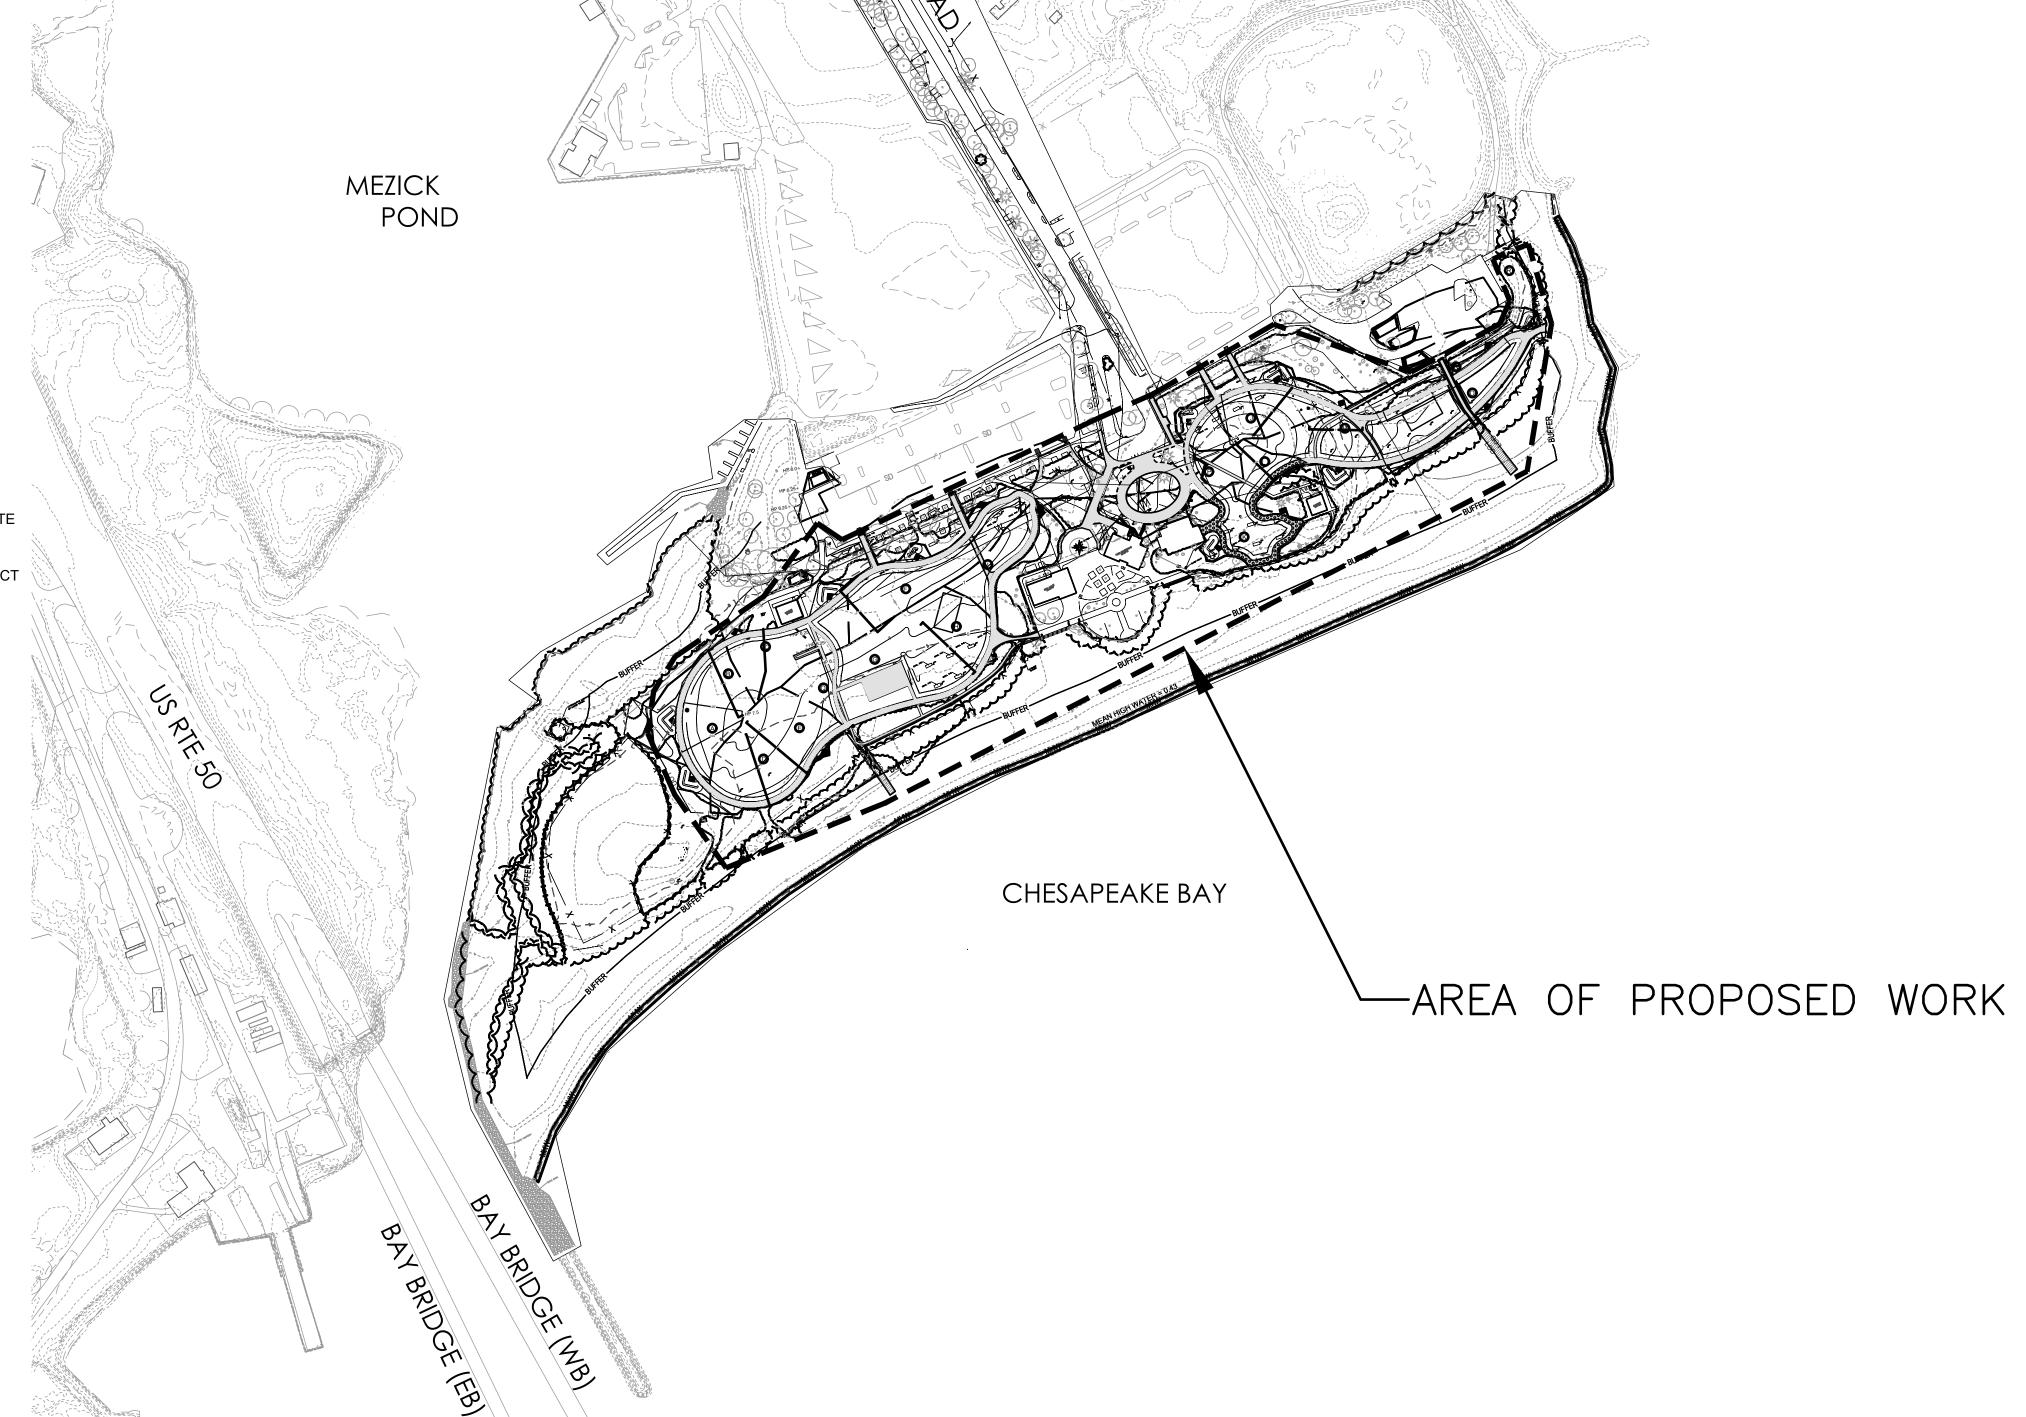


MDE PERMIT #23-SF-0169:







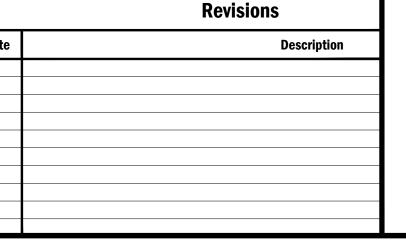

CALL BEFORE YOU DIG!

MARYLAND LAW REQUIRES 48 HOURS

NOTICE BEFORE PLANNED WORK TO

MARK UNDERGROUND UTILITIES

PRIOR TO EXCAVATION

MISS UTILITY: 1-800-257-7777



LOCATION MAP





Engineering Inc. Bay Engineering Inc. Alteration of this document by any party other than Ba

I Rights Reserved. Engineering Inc. is a violation of law that will be prosecuted to its fullest ex

email: info@bayengineering.com

www.bayengineering.com

## **COVER SHEET**

SANDY POINT STATE PARK SOUTH BEACH RESTORATION TAX ID: 03-000-29043249 TAX MAP 41, GRID 21, PARCEL 98 1100 E. COLLEGE PARKWAY

ANNAPOLIS, MARYLAND 21409

THIRD DISTRICT ANNE ARUNDEL COUNTY ZONED OS

SANDY POINT STATE PARK SOUTH BEACH RESTORATION Sheet No. C1



CONTROL NOTE

THE HORIZONTAL POSITION IS REFERENCED TO NAD83 AND THE VERTICAL POSITION IS REFERENCED TO NAVD88.

**Revisions** Description

Coastal Construction Services, LLC.

ANNAPOLIS ₹ ₹ ₽ LANDSCAPE




2661 Riva Road, Building 800 Annapolis, Maryland 21401 410.897.9290 email: info@bayengineering.com www.bayengineering.com


Copyright © 2021 Warning: This document is an instrument of professional service prepared by Bay Engineering Inc. Bay Engineering Inc. Alteration of this document by any party other than Bay Engineering Inc. is a violation of law that will be prosecuted to its fullest extent.


**OVERALL SITE PLAN** 

SANI SOU


IDY POINT STATE PARK	Drawn By NM				
UTH BEACH RESTORATION	Approved By MK				
TAX ID: 03-000-29043249 TAX MAP 41, GRID 21, PARCEL 98 1100 E. COLLEGE PARKWAY	Folder Reference SANDY POINT STATE PARK SOUTH BEACH RESTORATION				
ANNAPOLIS, MARYLAND 21409 THIRD DISTRICT ANNE ARUNDEL COUNTY ZONED OS	Sheet No. C2				

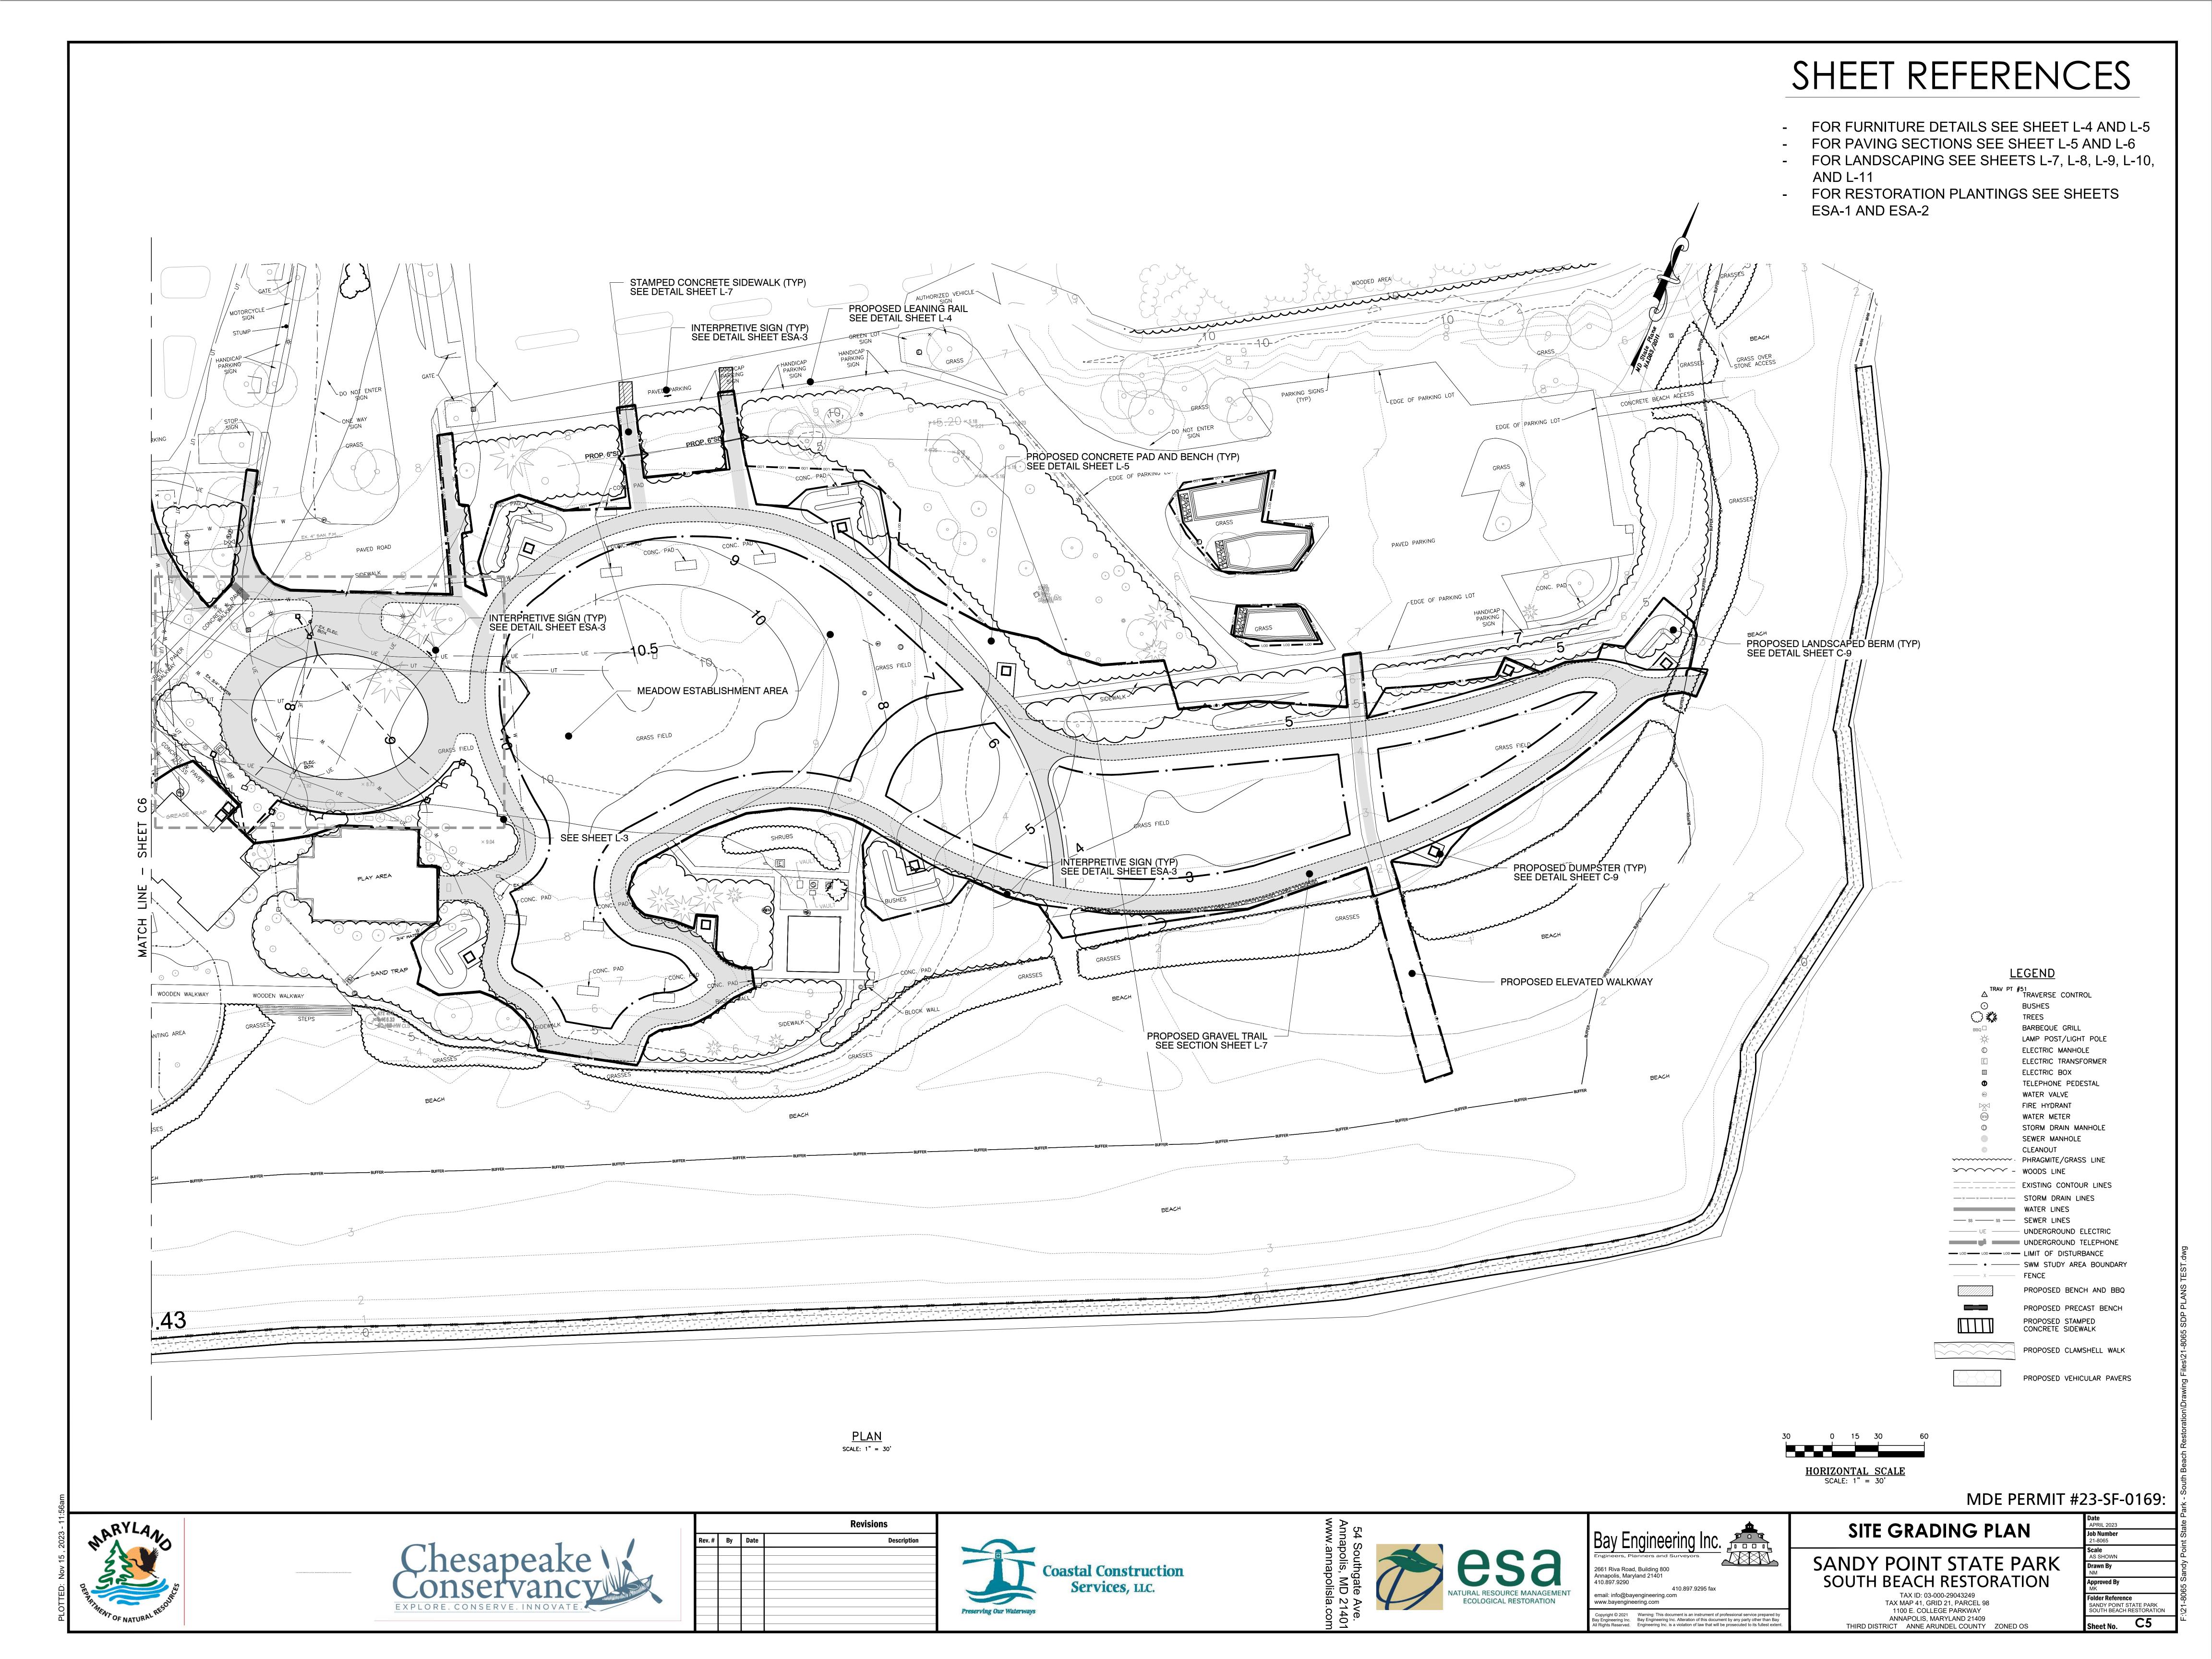


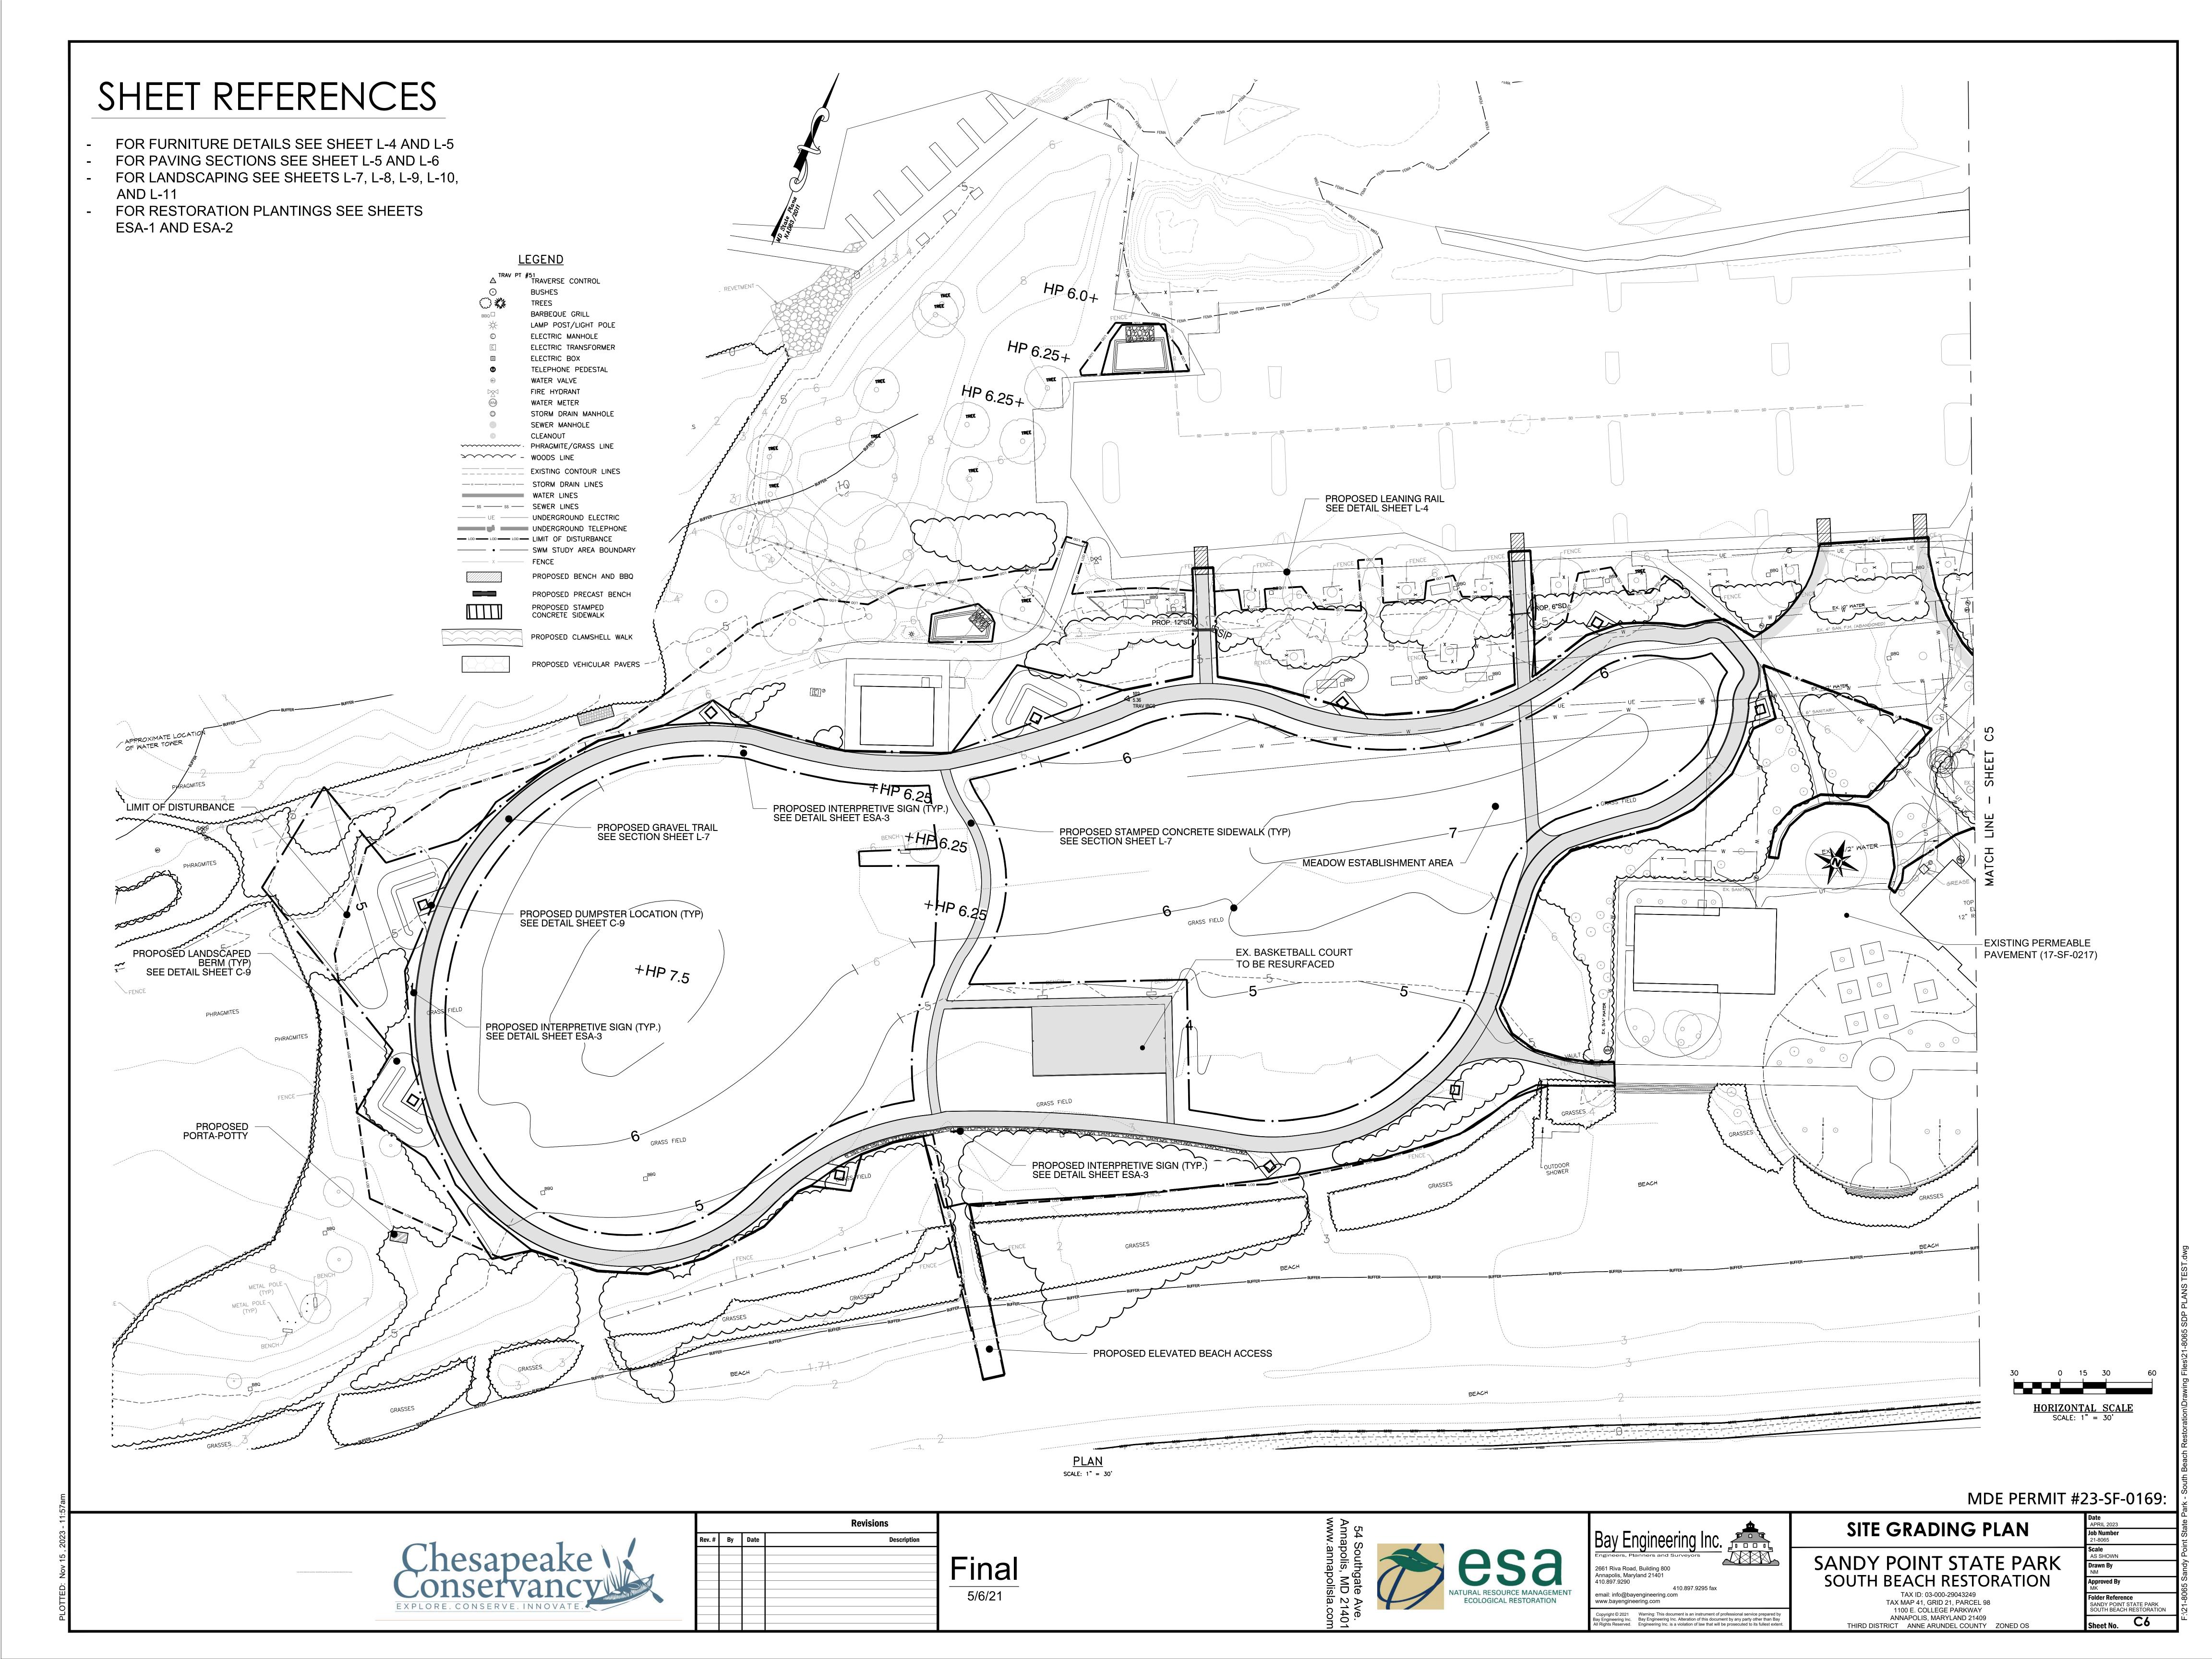

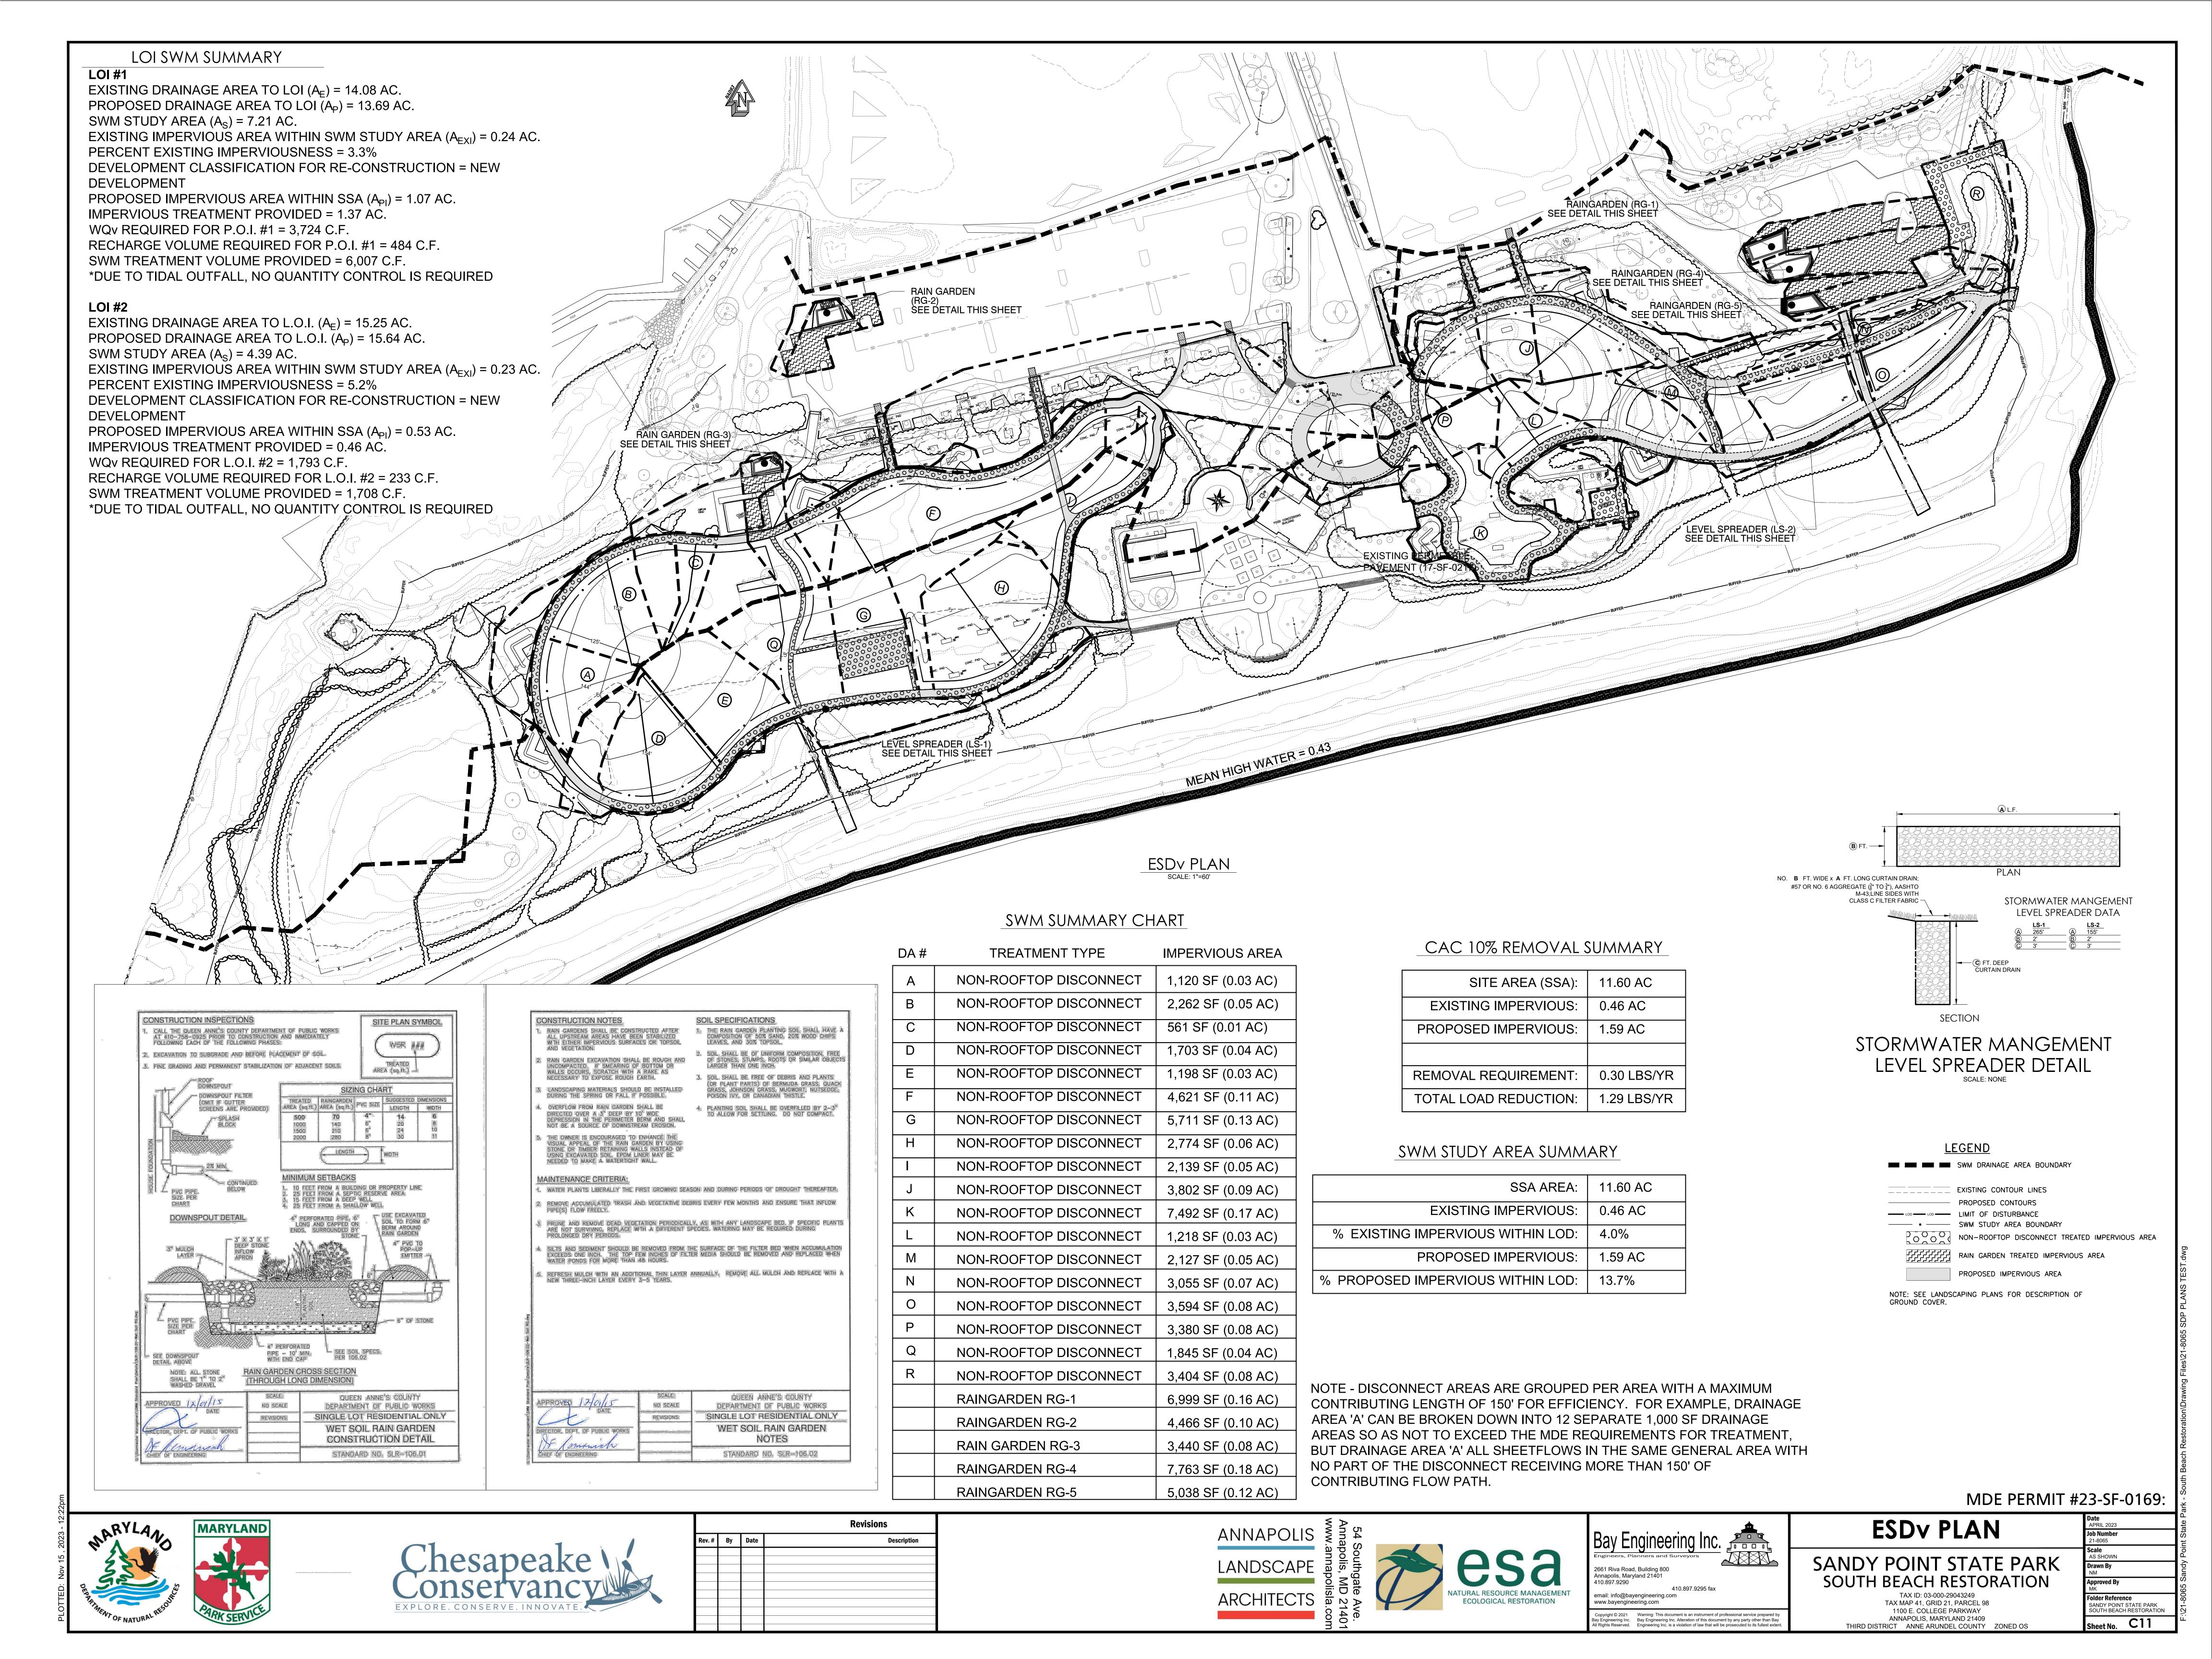




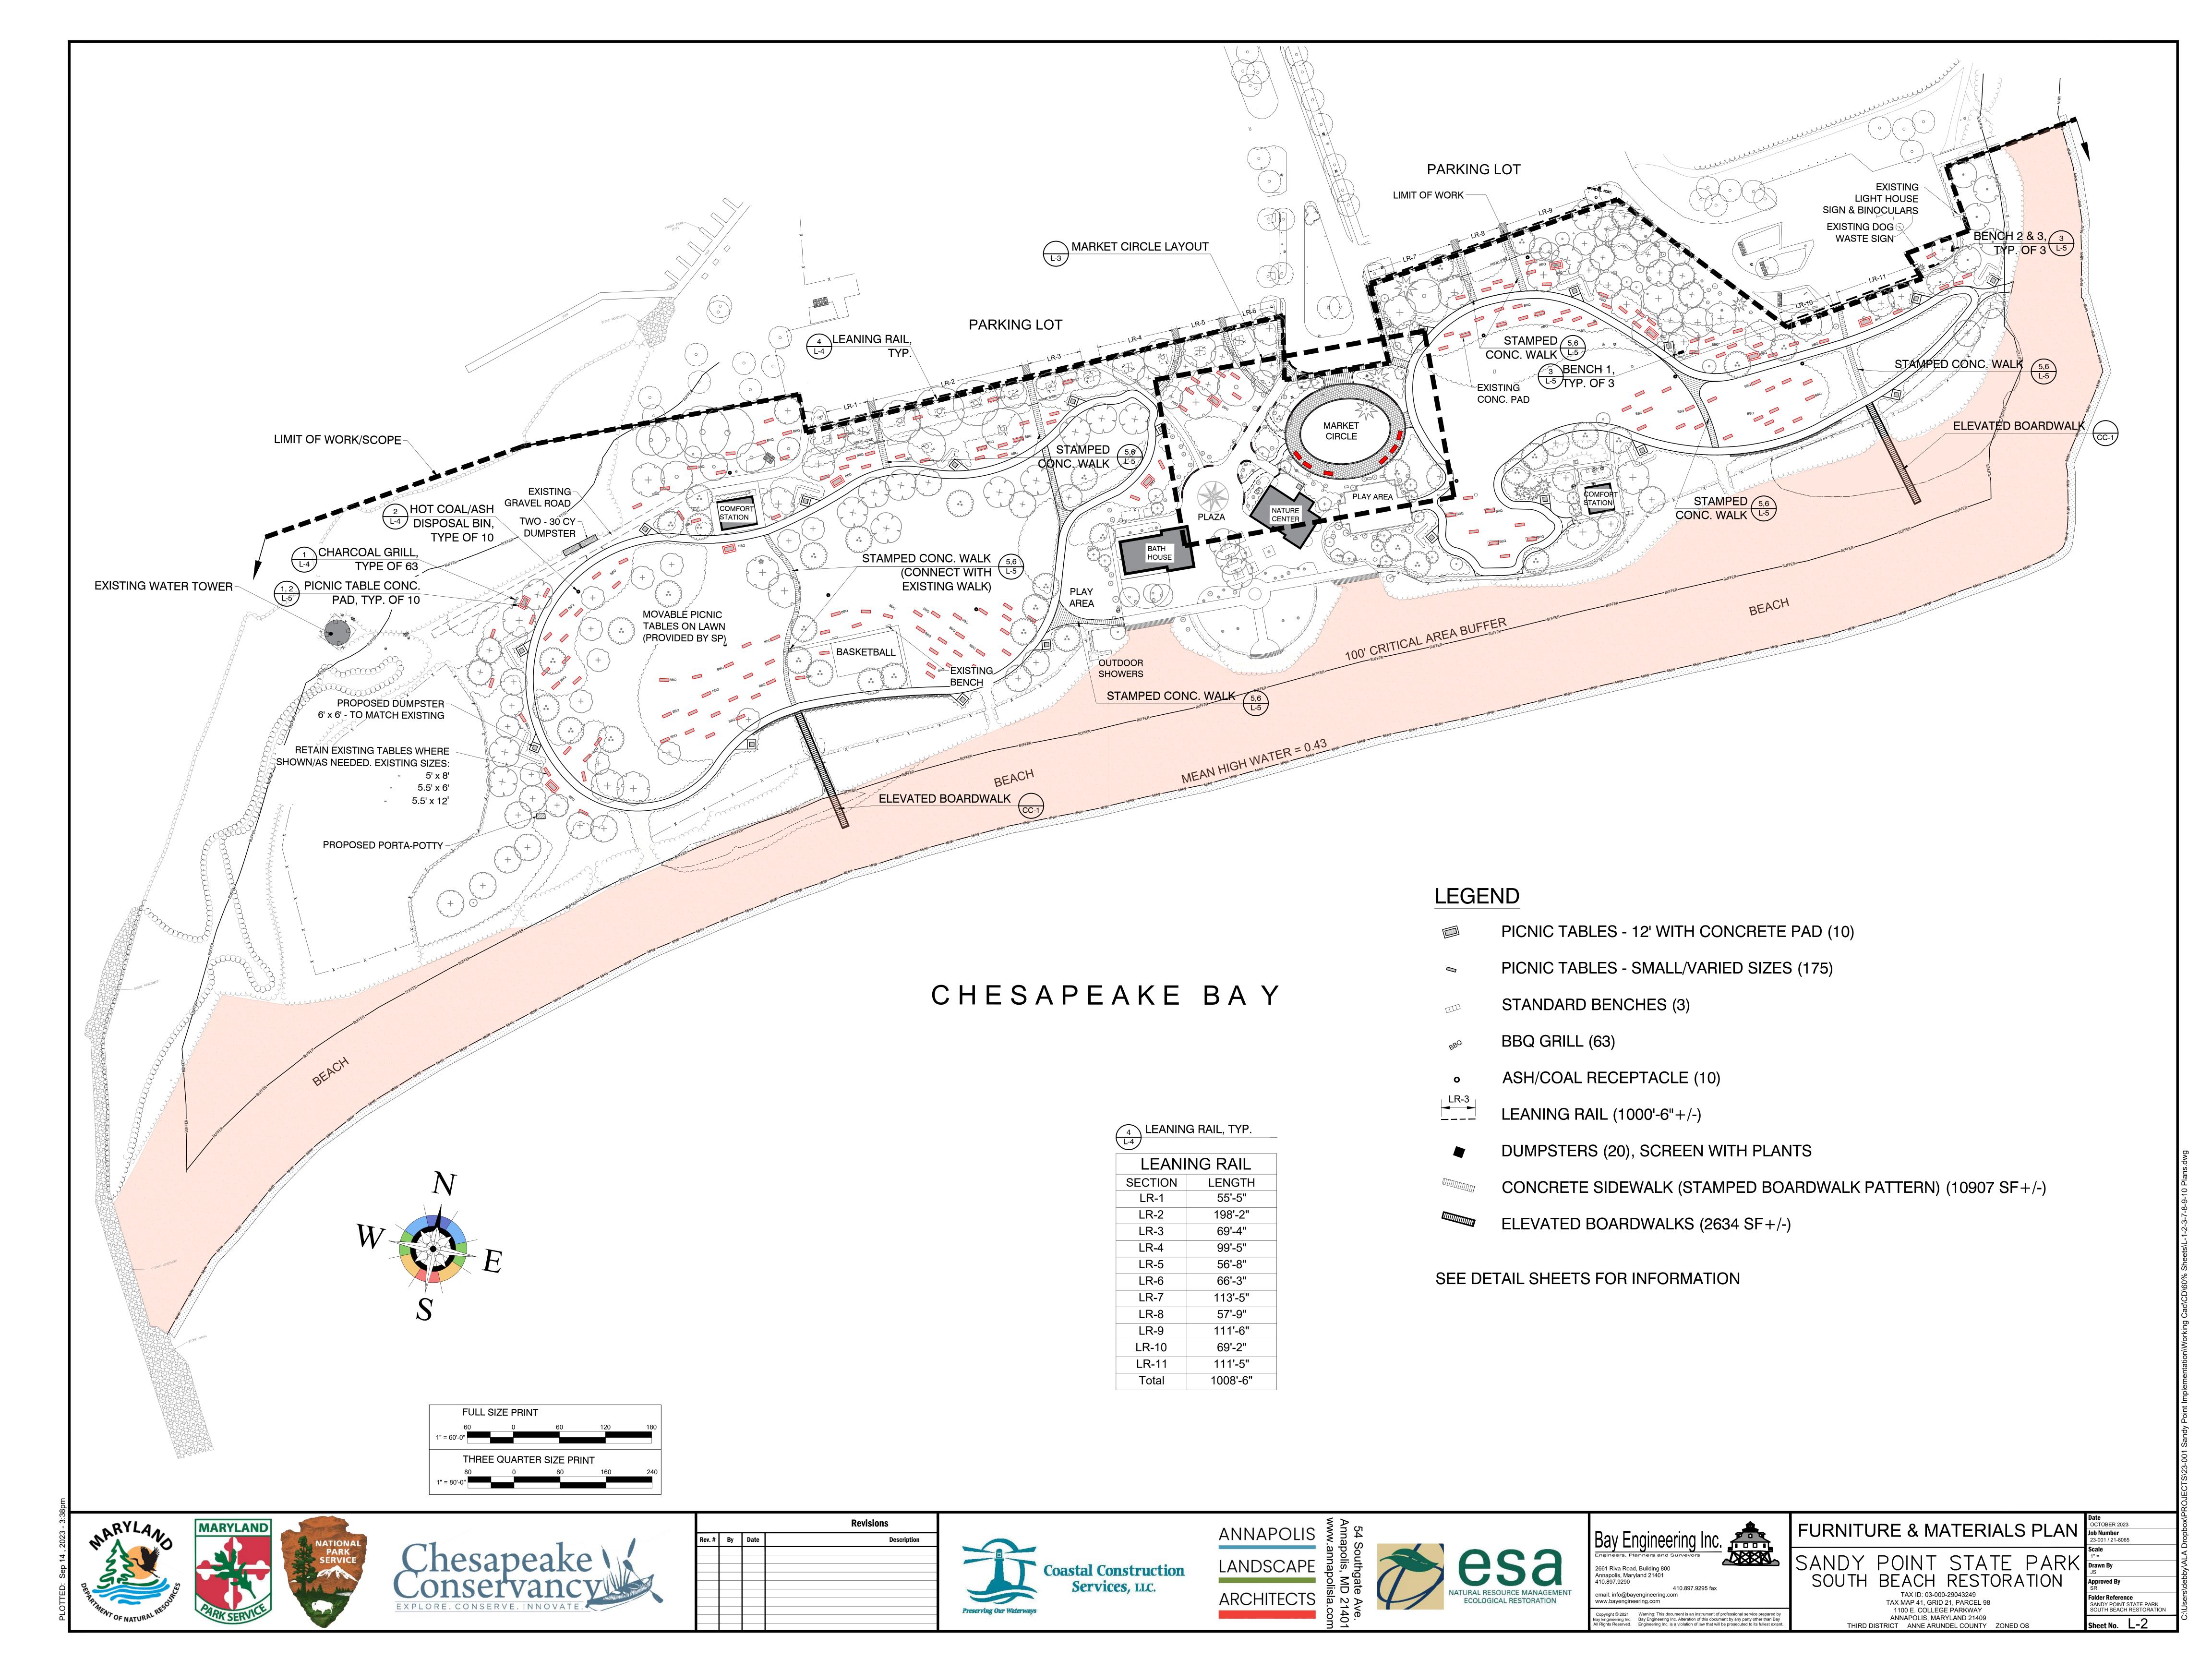

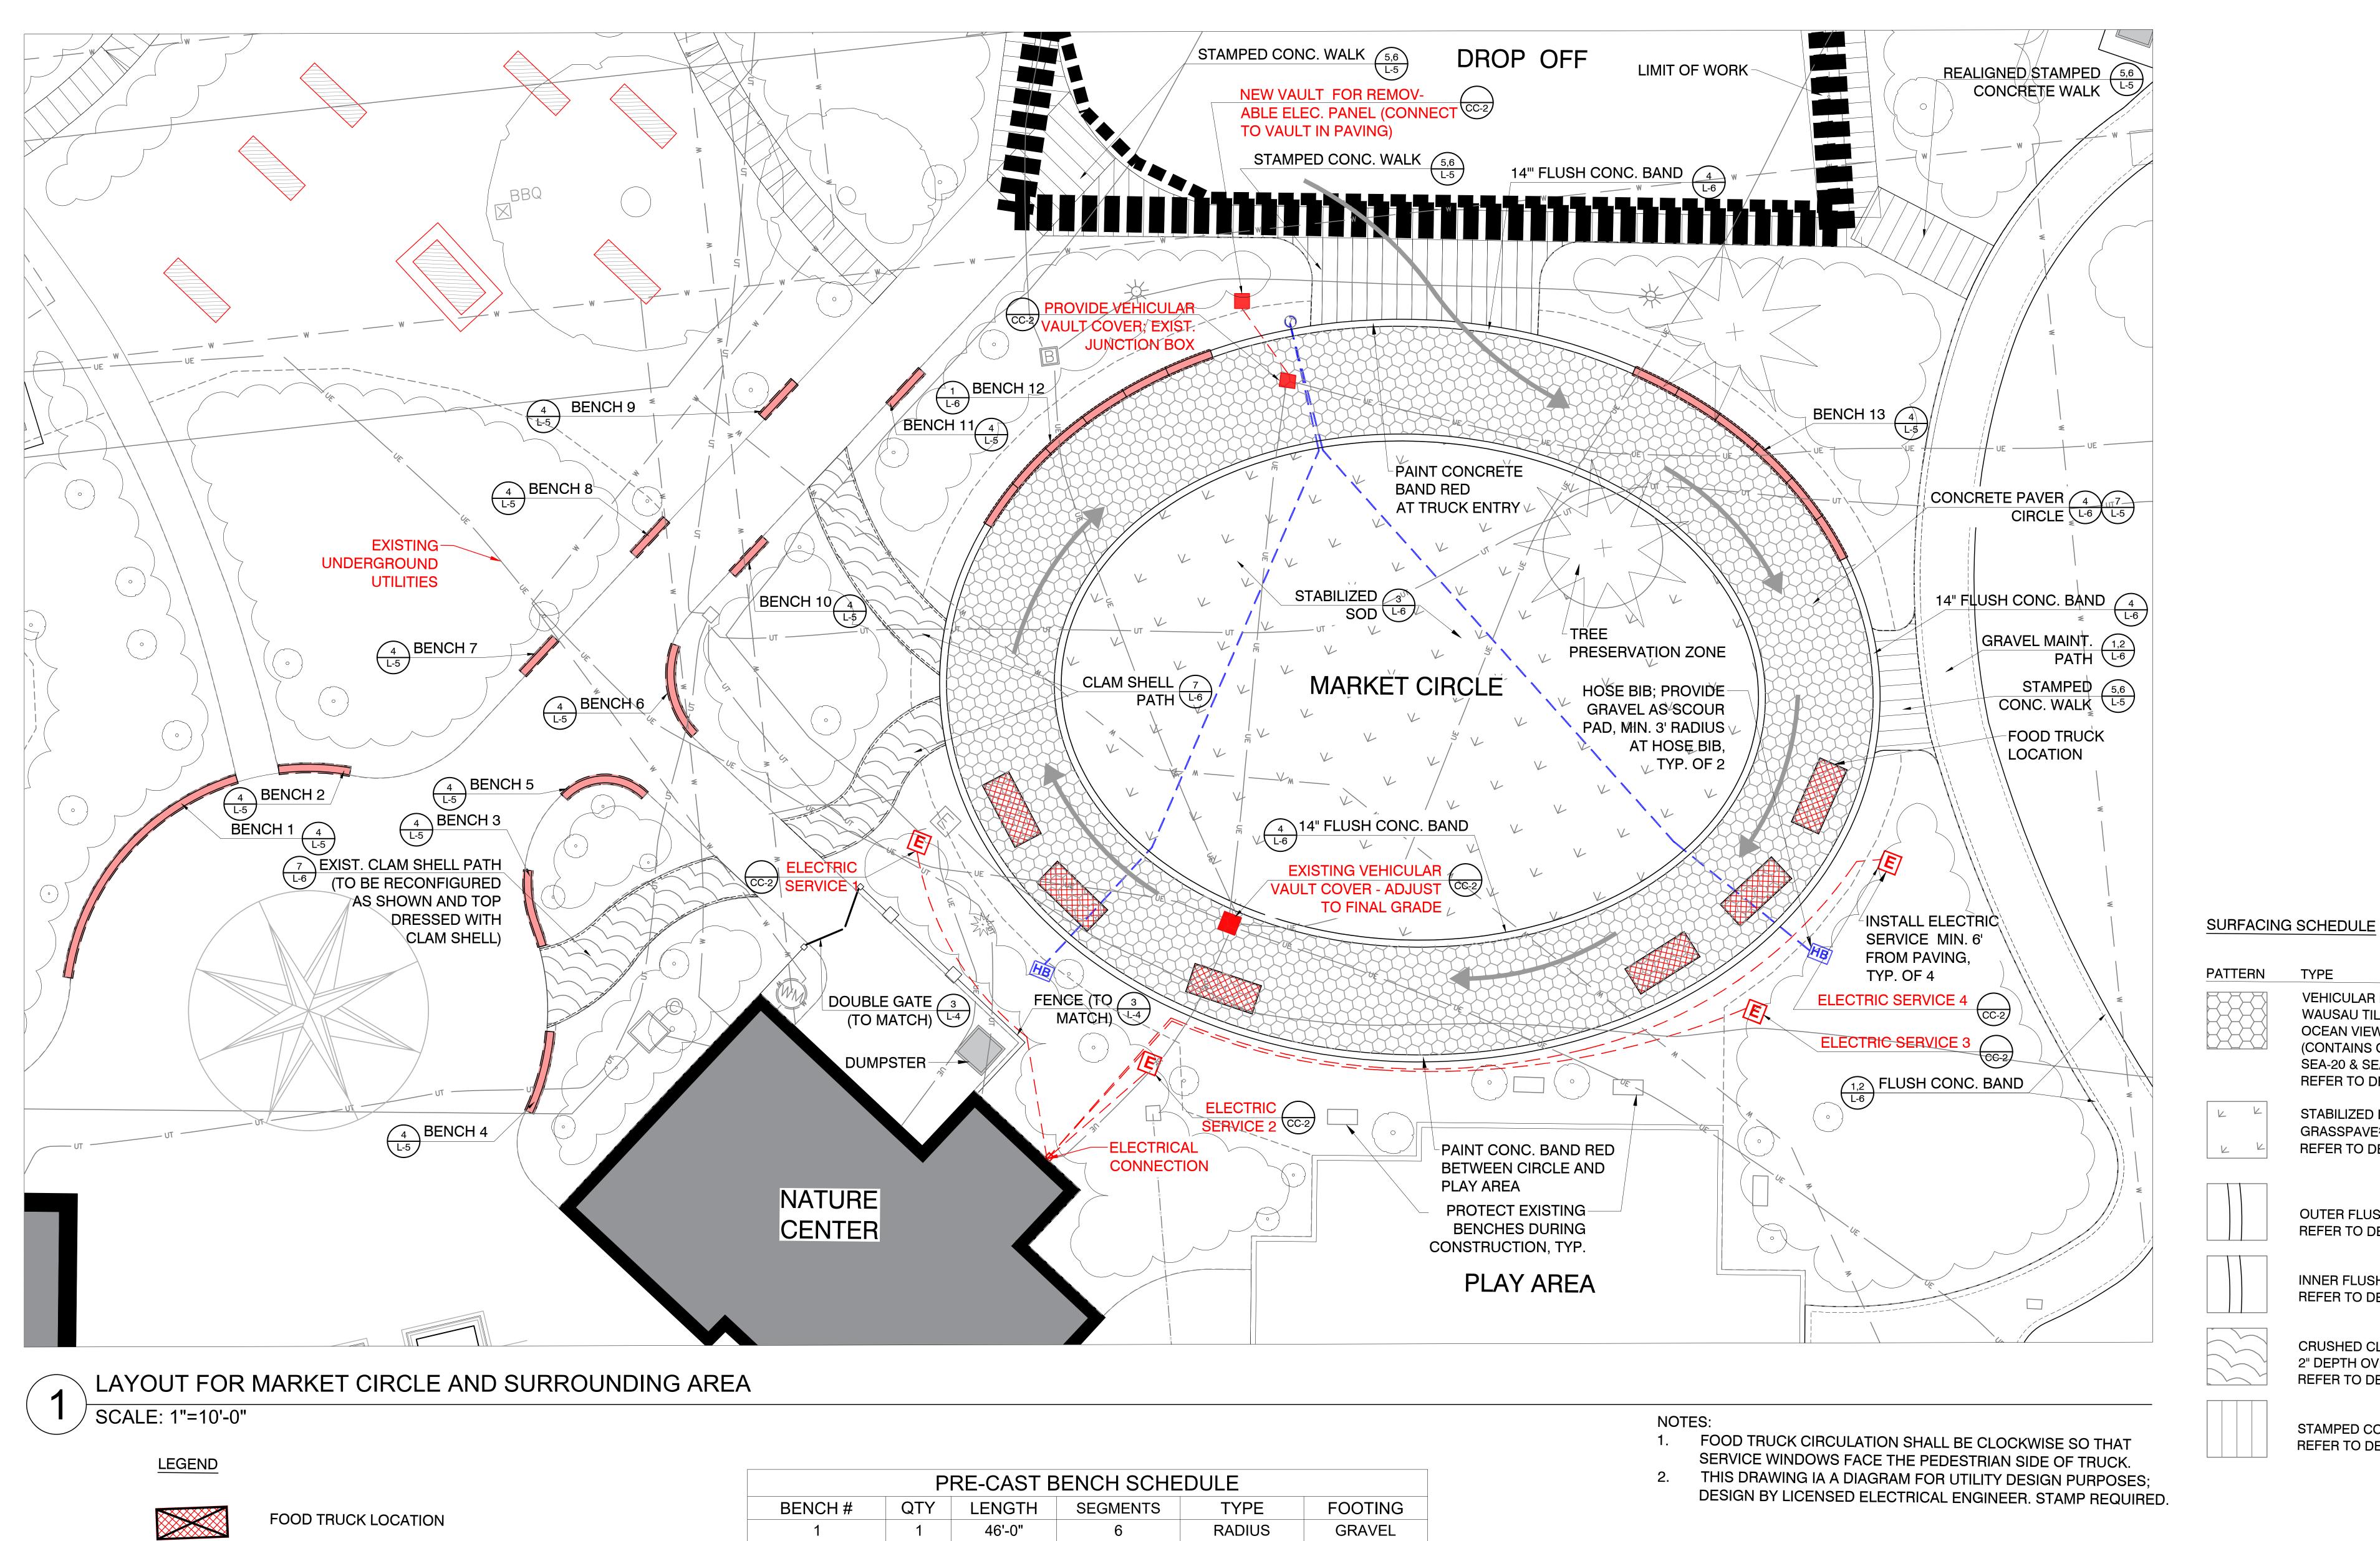


3'

FULL S	SIZE PRINT	Γ		
60	0	60	120	180
1" = 60'-0"				
	E QUARTE	R SIZE PRI	NT	
	E QUARTE	R SIZE PRI	NT 160	240

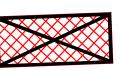




CONCEPTUAL ELECTRIC TO BE DESIGNED BY ELECTRICAL ENGINEER, LOCATE 6' OFF OF ELLIPTICAL PAVING

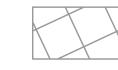

PAVING TO BE REMOVED

FOOD TRUCK DRIVING DIRECTION

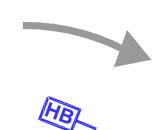

HOSE BIB, LOCATE MIN. 6' OFF OF ELLIPTICAL PAVING, GRAVEL AS SCOUR PAD AT BASE OF AND AROUND PIPING


BENCH#	QTY	LENGTH	SEGMENTS	TYPE	FOOTING
1	1	46'-0"	6	RADIUS	GRAVEL
2	1	12'-0"	1	RADIUS	GRAVEL
3	1	13'-0"	1	RADIUS	GRAVEL
4	1	14'-0"	1	RADIUS	GRAVEL
5	1	15'-0"	1	RADIUS	GRAVEL
6	1	16'-0"	1	RADIUS	GRAVEL
7, 8, 9, 10, 11	5	8'-0"	1	STRAIGHT	GRAVEL
12	1	48'-0"	6	ELLIPSE	CONCRETE
13	1	48'-0"	6	ELLIPSE	CONCRETE

FINISH - ACID ETCH COLOR - TO BE DETERMINED







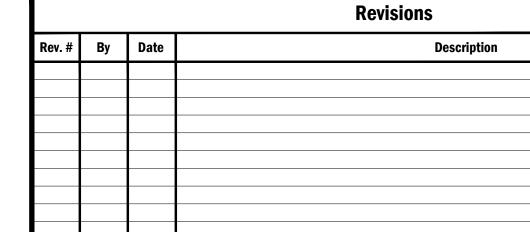









Copyright © 2021 Warning: This document is an instrument of professional service prepared by ay Engineering Inc.

Bay Engineering Inc. Alteration of this document by any party other than Bay Engineering Inc. is a violation of law that will be prosecuted to its fullest extent

ľ	<b>M</b>	A	R	K	E	Τ	C	:IF	20	CL	.E	: [	_/	4}	/(	Οl	J	Τ
									_									

TYPE

VEHICULAR PAVING

STABILIZED LAWN

GRASSPAVE<sup>2</sup>

OCEAN VIEW PAVERS

(CONTAINS CRUSHED CLAM SHELLS,

REFER TO DETAIL X, SHEET XX

OUTER FLUSH CONCRETE BAND

REFER TO DETAIL 4, SHEET L-6

INNER FLUSH CONCRETE BAND

REFER TO DETAIL 4, SHEET L-6

CRUSHED CLAM SHELL PATH,

2" DEPTH OVER 4" STONE DUST

REFER TO DETAIL 6, SHEET L-6

STAMPED CONCRETE WALK

REFER TO DETAIL 5 & 6, SHEET L-5

SEA-20 & SEA-50, 8" HEXAGON, 7,500 PSI;

REFER TO DETAIL 3, SHEET L-6 AND NOTES

**WAUSAU TILE** 

SANDY POINT STATE PARK Drawn By SOUTH BEACH RESTORATION TAX ID: 03-000-29043249 TAX MAP 41, GRID 21, PARCEL 98 1100 E. COLLEGE PARKWAY

ANNAPOLIS, MARYLAND 21409

THIRD DISTRICT ANNE ARUNDEL COUNTY ZONED OS

Approved By SANDY POINT STATE PARK SOUTH BEACH RESTORATION Sheet No. L-3

AREA

6840 SF

7365 SF


443 LF


317 LF

890 SF

5.49 CY

(CLAM SHELL)

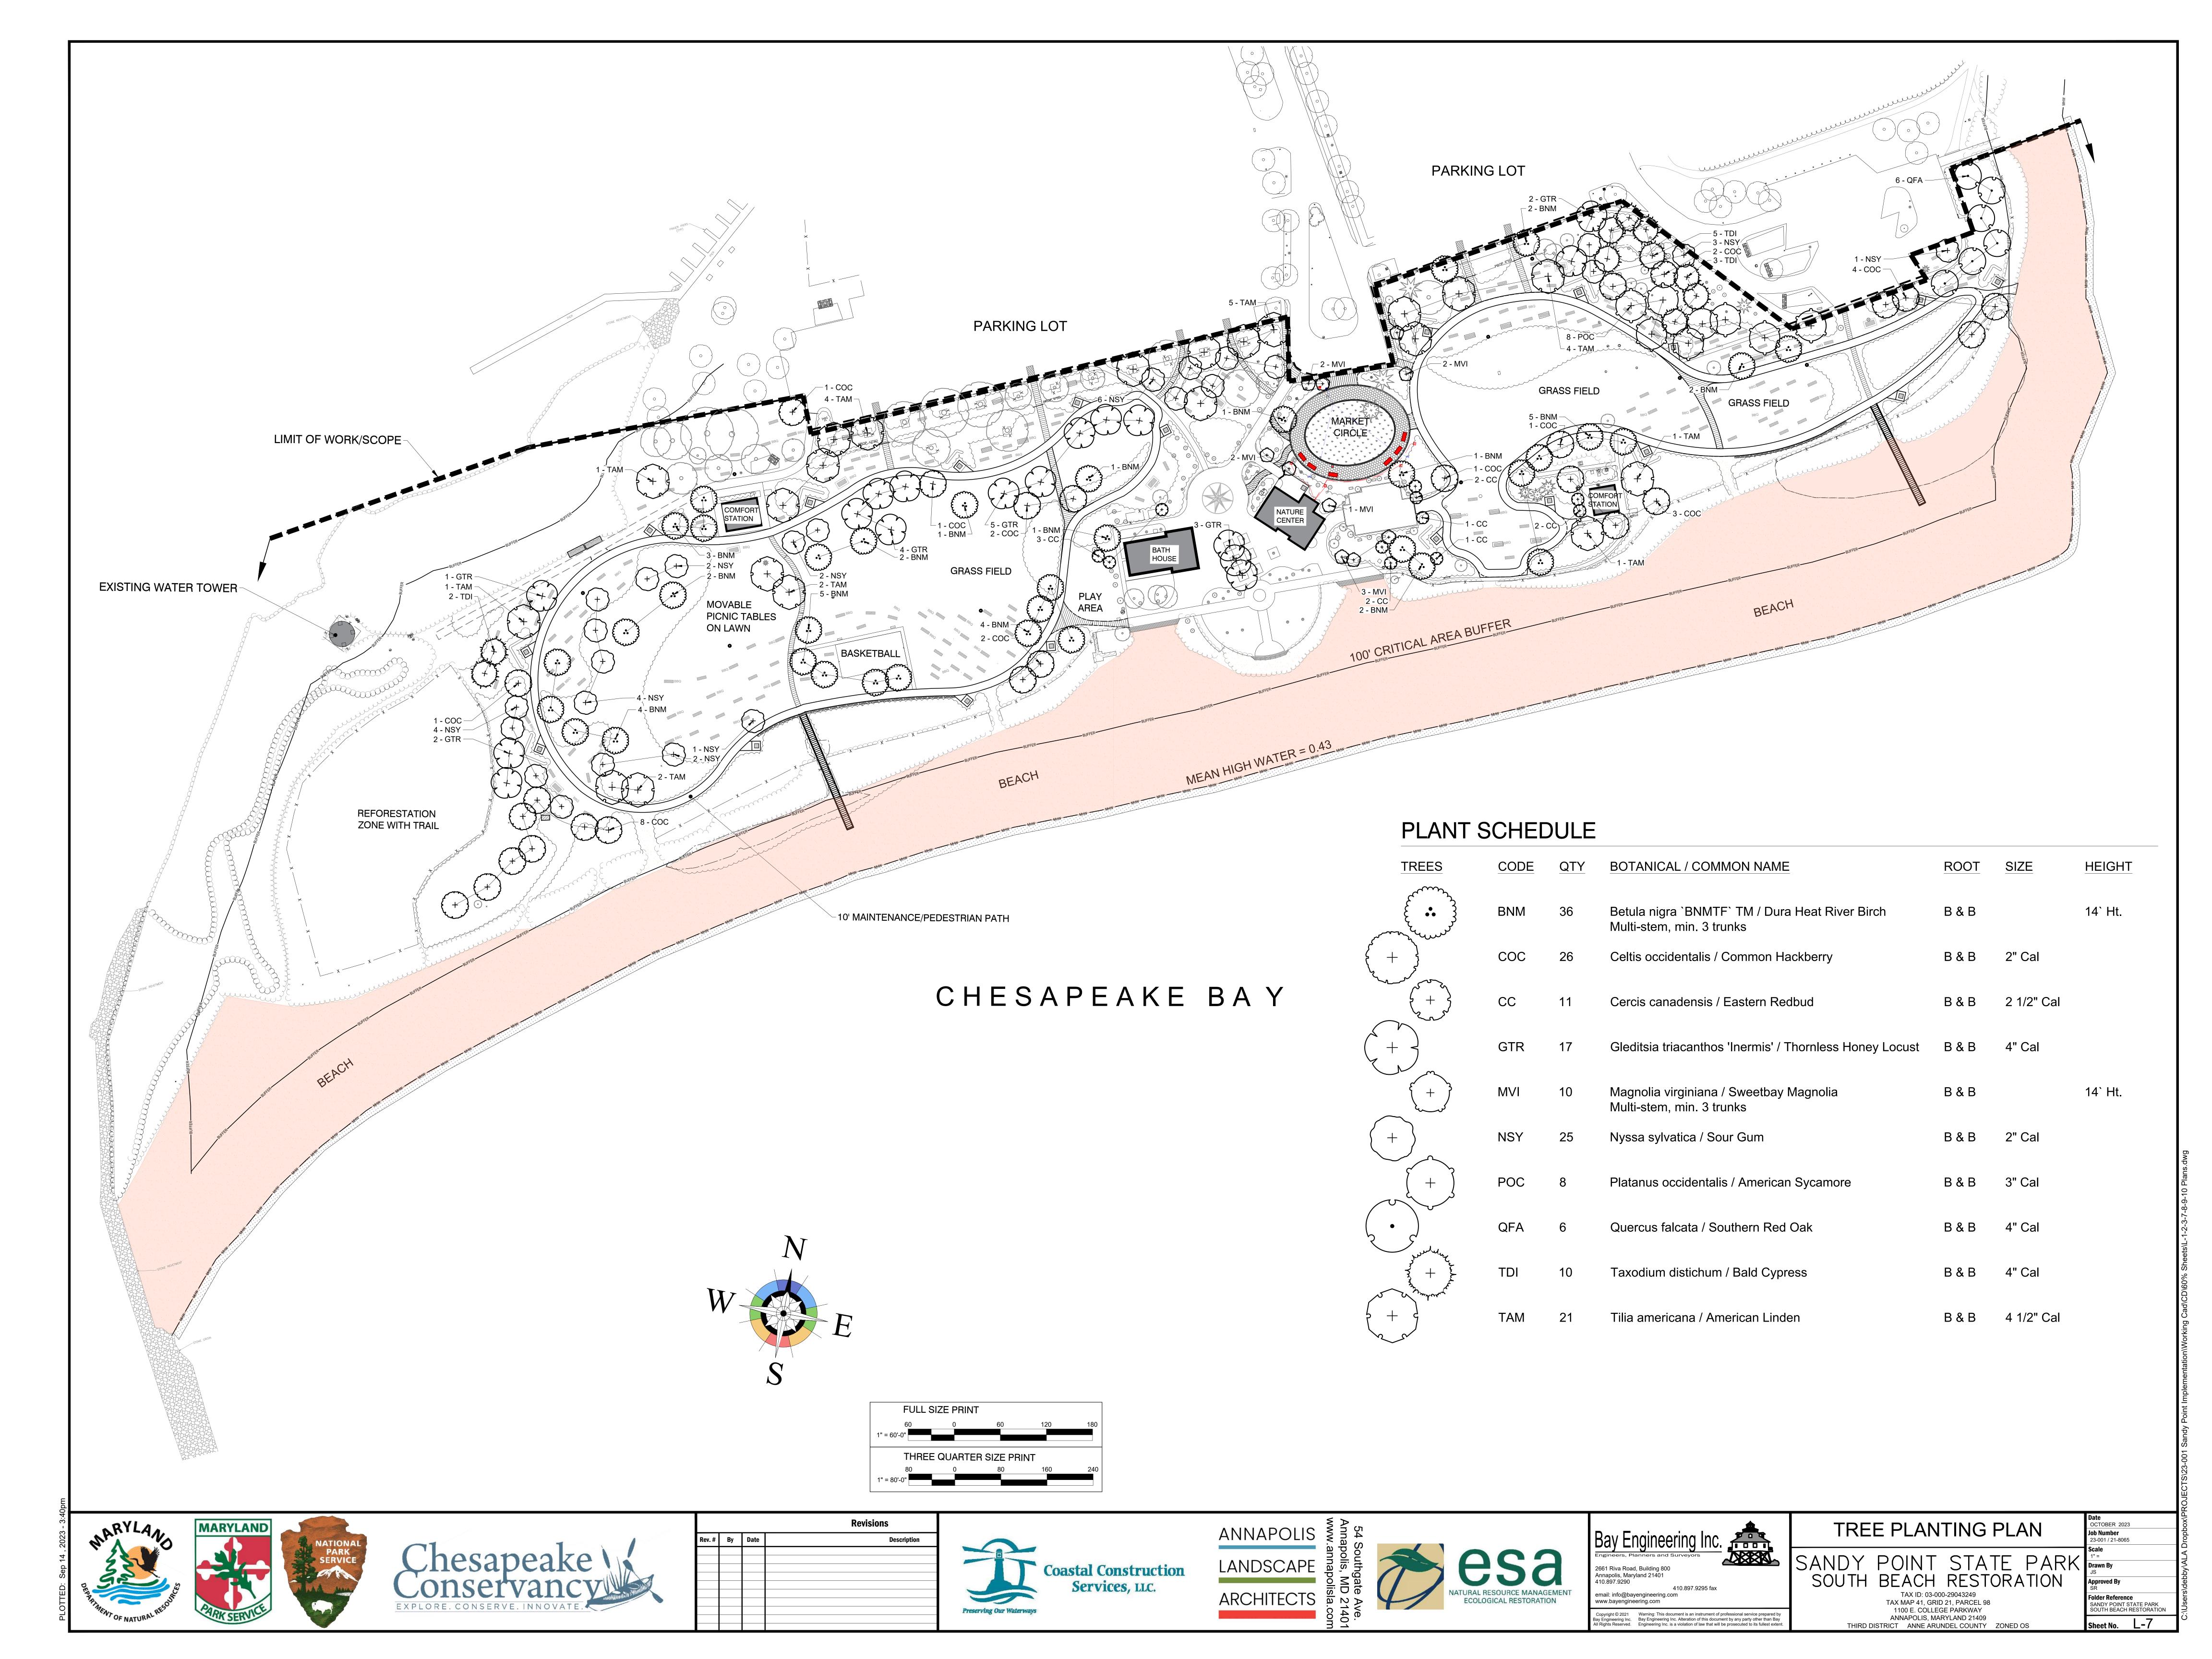

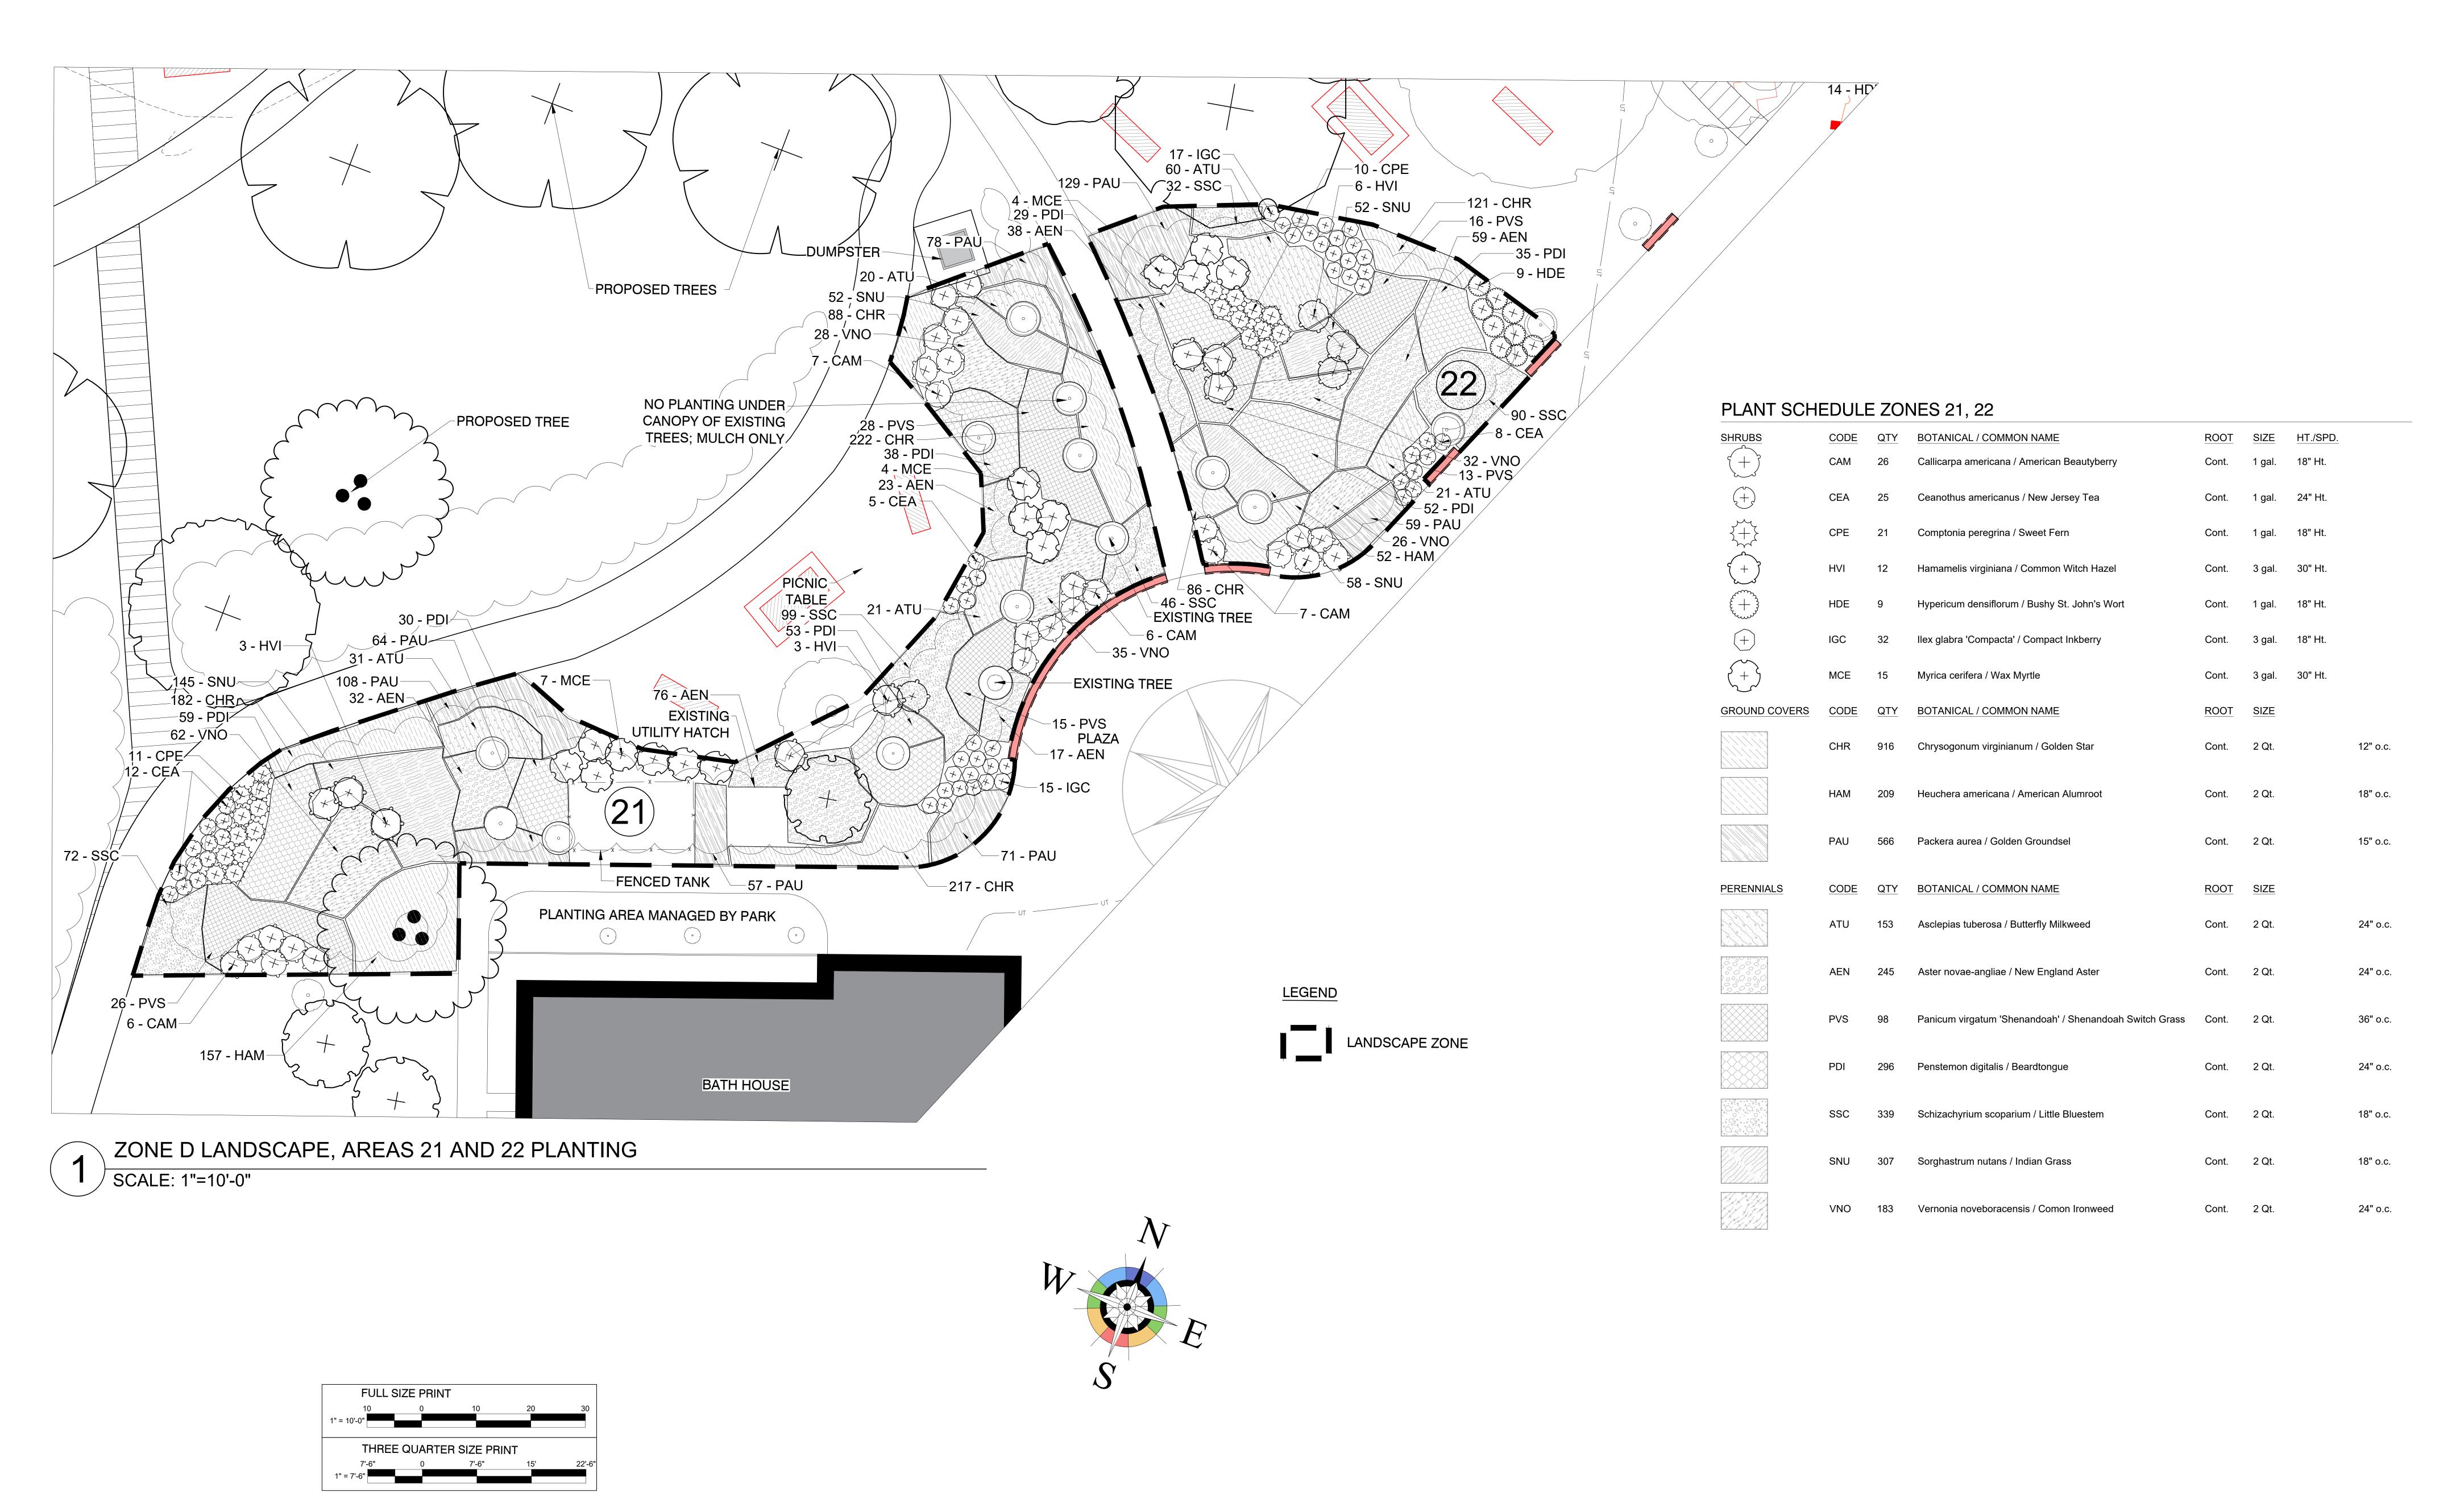

PLOTTED: Sep 14, 2023 - 3:41pm


BLOTTED: Sep 14, 2023 - 3:41pm

BLOTTED: Sep 14, 2023 - 3:41pm

BLOTTED: Sep 14, 2023 - 3:41pm






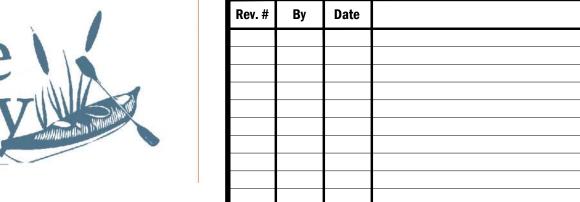

**Revisions** 

Description



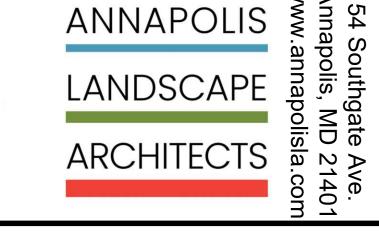





Copyright © 2021

Bay Engineering Inc.

All Rights Reserved.

Warning: This document is an instrument of professional service prepared by Bay Engineering Inc. Alteration of this document by any party other than Bay Engineering Inc. is a violation of law that will be prosecuted to its fullest extent.



SANDY POINT STATE PARK
SOUTH BEACH RESTORATION

TAX ID: 03-000-29043249

TAX MAP 41, GRID 21, PARCEL 98
1100 E. COLLEGE PARKWAY
ANNAPOLIS, MARYLAND 21409
THIRD DISTRICT ANNE ARUNDEL COUNTY ZONED OS

TIT =


Drawn By
JS

Approved By
SR

Folder Reference
SANDY POINT STATE PARK
SOUTH BEACH RESTORATION

Sheet No. L-8

Job Number

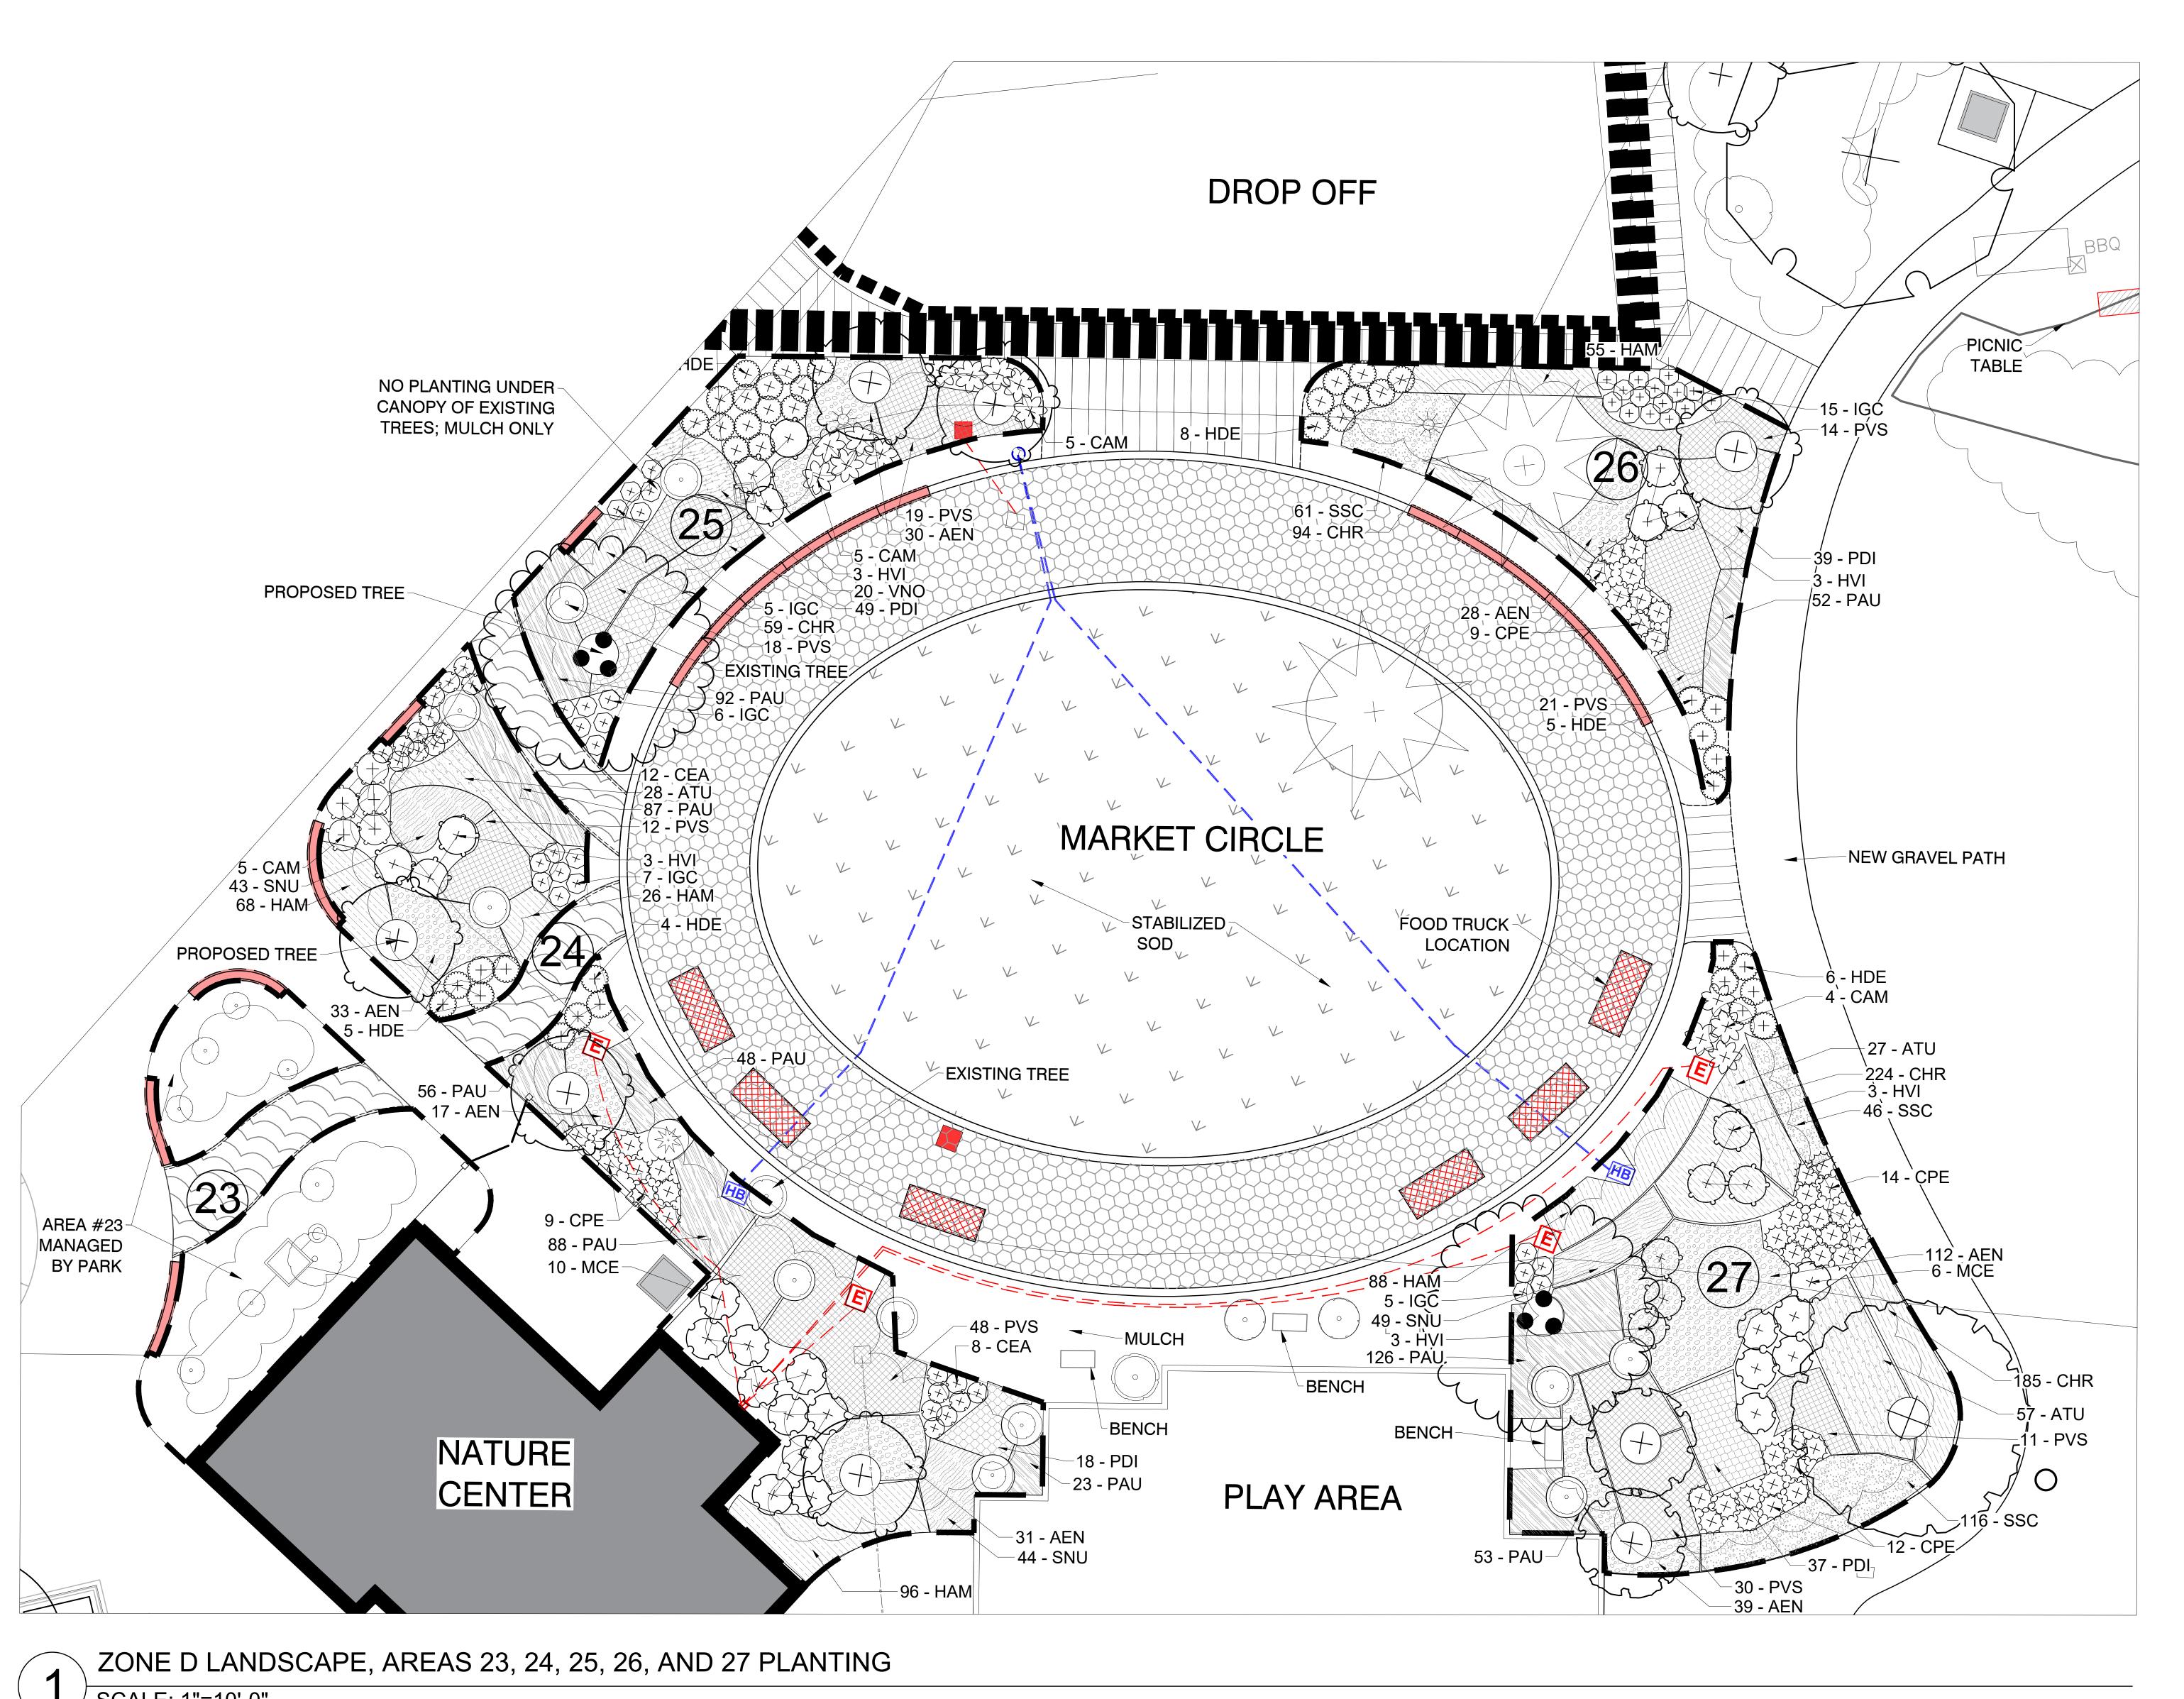

**SHRUBS** CODE QTY BOTANICAL / COMMON NAME Callicarpa americana / American Beautyberry Cont. 1 gal. 24" Ht. Ceanothus americanus / New Jersey Tea Comptonia peregrina / Sweet Fern Cont. 3 gal. 30" Ht. Hamamelis virginiana / Common Witch Hazel Hypericum densiflorum / Bushy St. John's Wort Ilex glabra 'Compacta' / Compact Inkberry Cont. 3 gal. 30" Ht. Myrica cerifera / Wax Myrtle QTY BOTANICAL / COMMON NAME 12" o.c. Cont. 2 Qt. 562 Chrysogonum virginianum / Golden Star 18" o.c. Cont. 2 Qt. 333 Heuchera americana / American Alumroot 625 Packera aurea / Golden Groundsel 15" o.c. Cont. 2 Qt. ROOT SIZE **PERENNIALS** QTY BOTANICAL / COMMON NAME 24" o.c. ATU 112 Asclepias tuberosa / Butterfly Milkweed Cont. 2 Qt. AEN 290 Aster novae-angliae / New England Aster 24" o.c. Cont. 2 Qt.

PVS 173 Panicum virgatum 'Shenandoah' / Shenandoah Switch Grass

Vernonia noveboracensis / Comon Ironweed

143 Penstemon digitalis / Beardtongue

136 Sorghastrum nutans / Indian Grass

223 Schizachyrium scoparium / Little Bluestem

PLANT SCHEDULE ZONES 23, 24, 25, 26, 27

<u>LEGEND</u>

LANDSCAPE ZONE

FULL SIZE PRINT

10 0 10 20 30

1" = 10'-0"

THREE QUARTER SIZE PRINT


7'-6" 0 7'-6" 15' 22'-6"

1" = 7'-6"







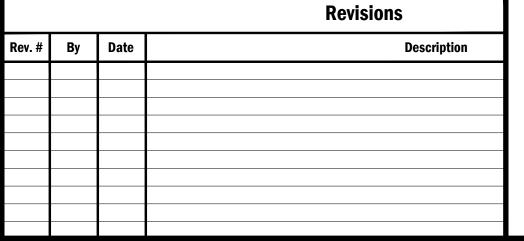









Copyright © 2021 Warning: This document is an instrument of professional service prepared by Bay Engineering Inc. Alteration of this document by any party other than Bay Engineering Inc. is a violation of law that will be prosecuted to its fullest extent.



SANDY POINT STATE PARK
SOUTH BEACH RESTORATION

TAX ID: 03-000-29043249

TAX MAP 41, GRID 21, PARCEL 98

1100 E. COLLEGE PARKWAY
ANNAPOLIS, MARYLAND 21409

THIRD DISTRICT ANNE ARUNDEL COUNTY ZONED OS

Date
OCTOBER 2023

Job Number
23-001 / 21-8065

Scale
1" =

Drawn By
JS

Approved By
SR

Folder Reference
SANDY POINT STATE PARK
SOUTH BEACH RESTORATION

Sheet No. L-9

36" o.c.

24" o.c.

18" o.c.

18" o.c.


24" o.c.


Cont. 2 Qt.

Cont. 2 Qt.


Cont. 2 Qt.

Cont. 2 Qt.

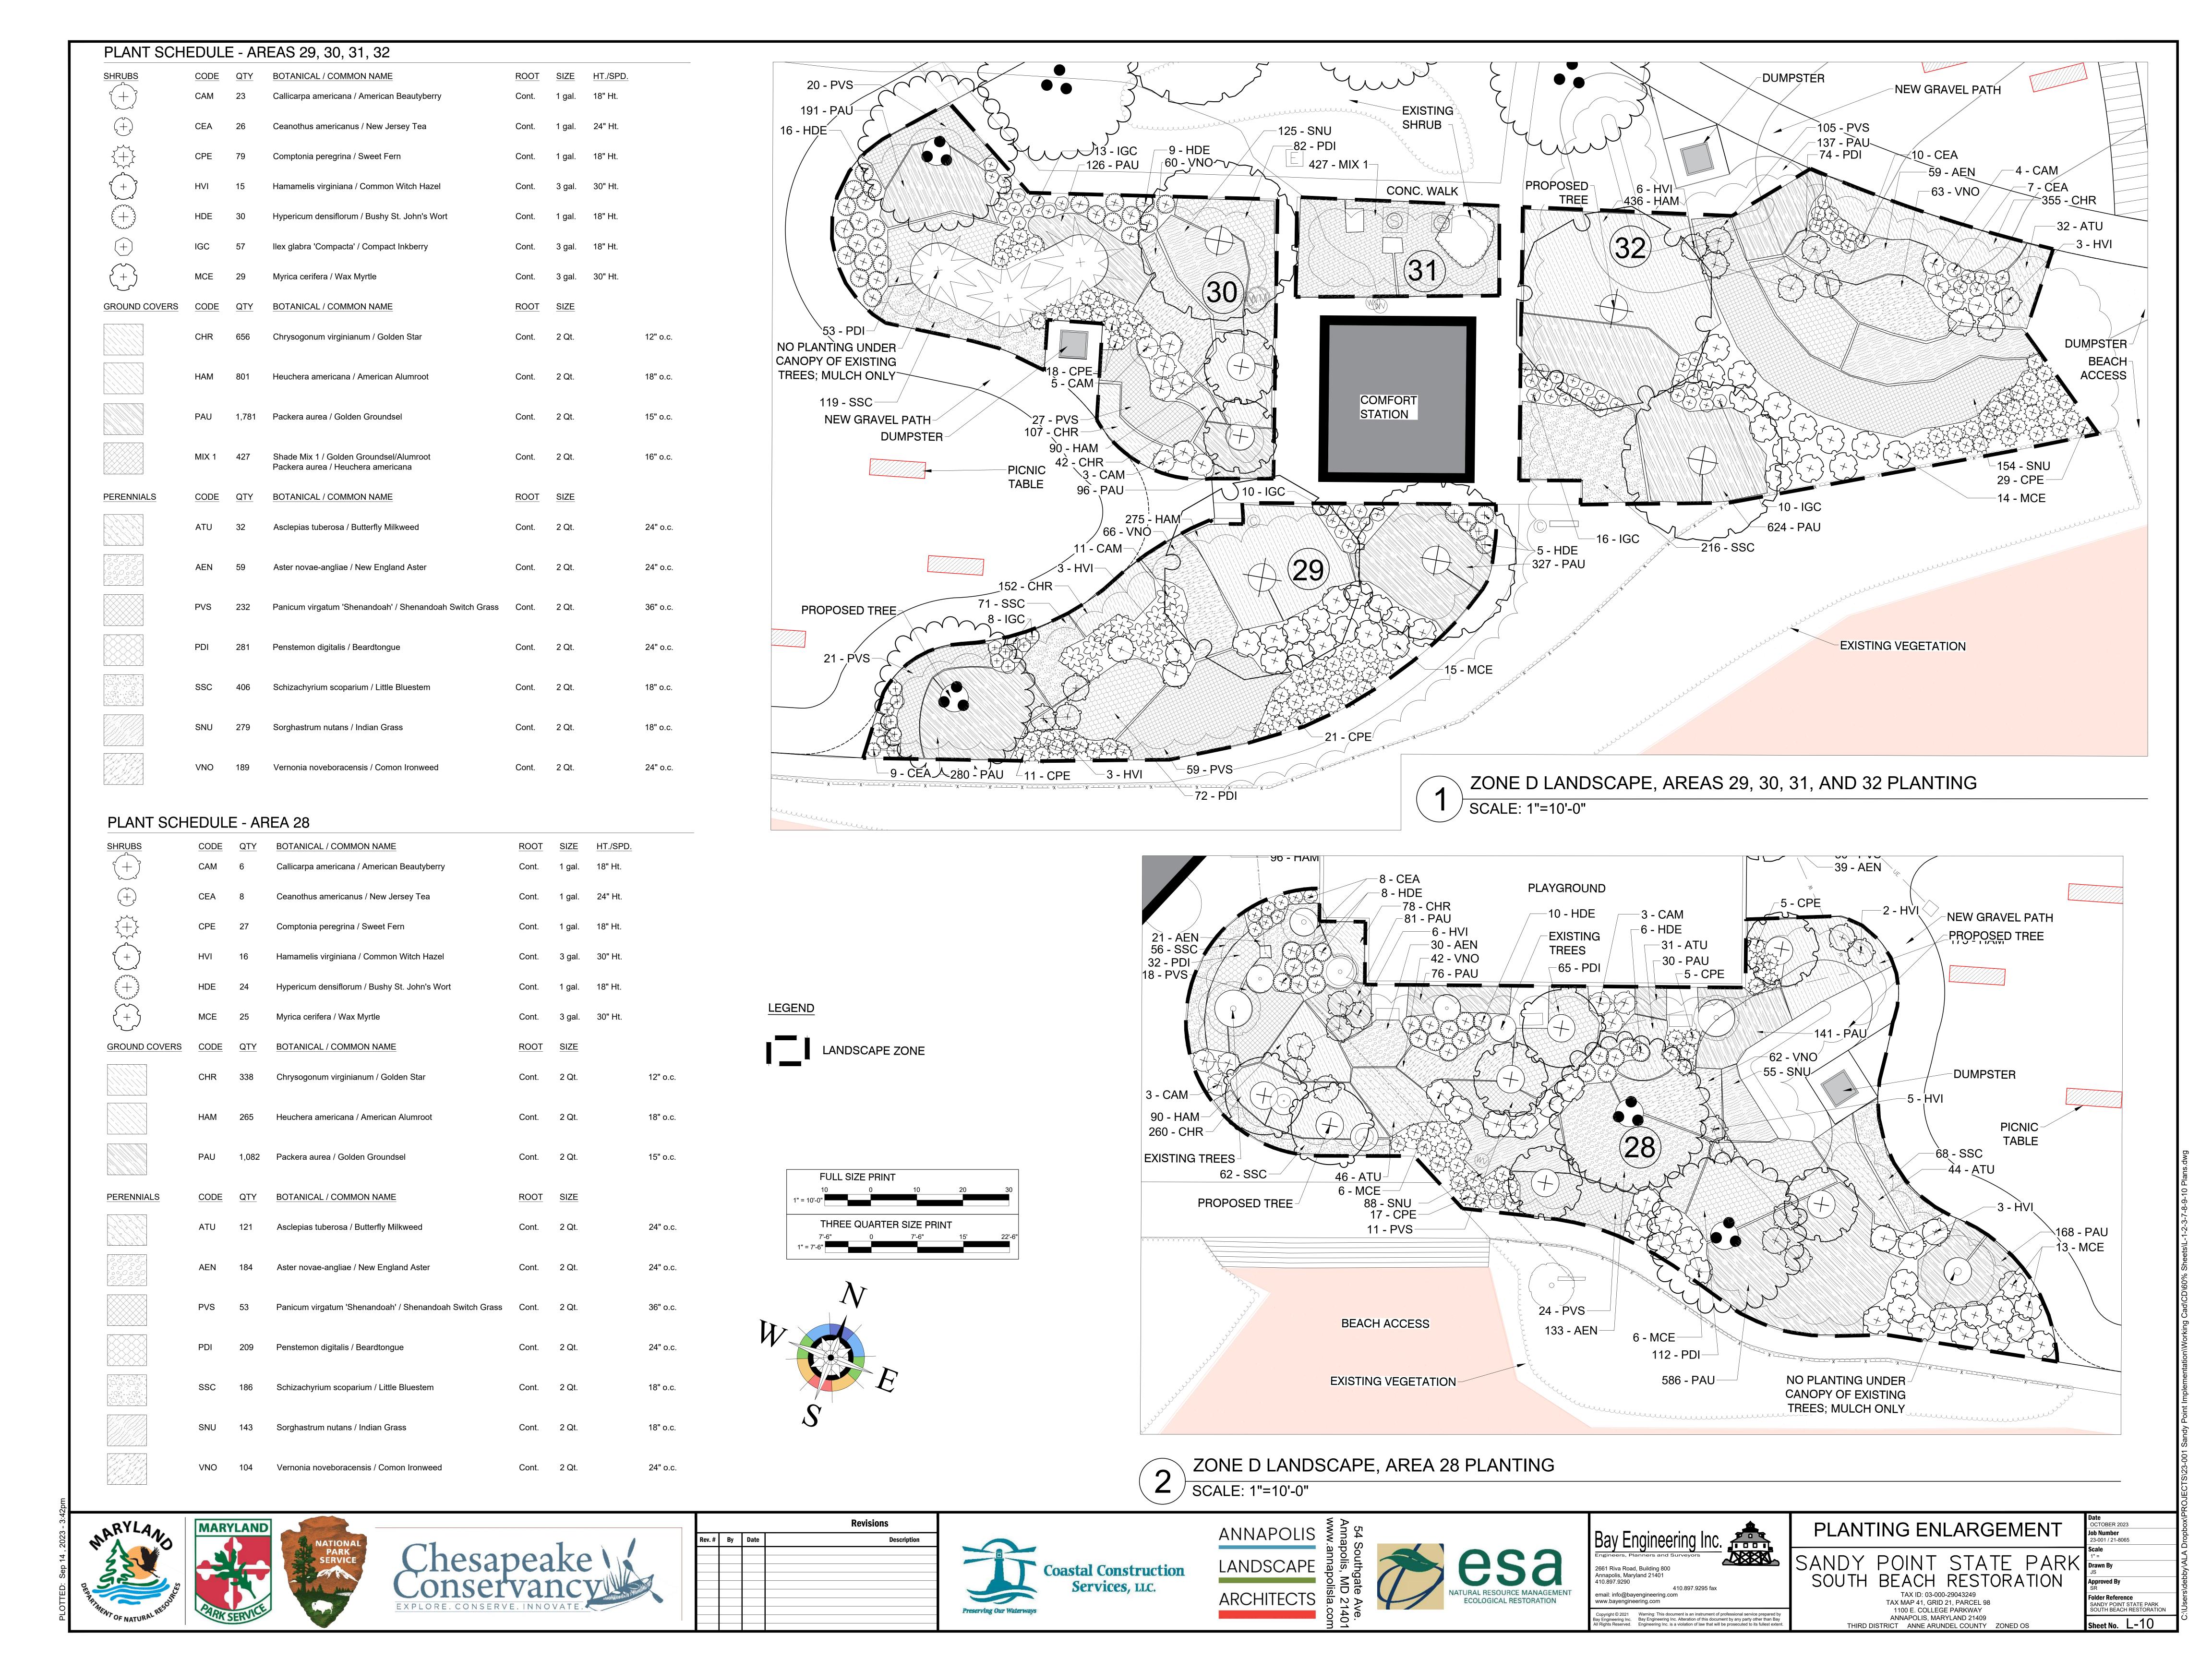


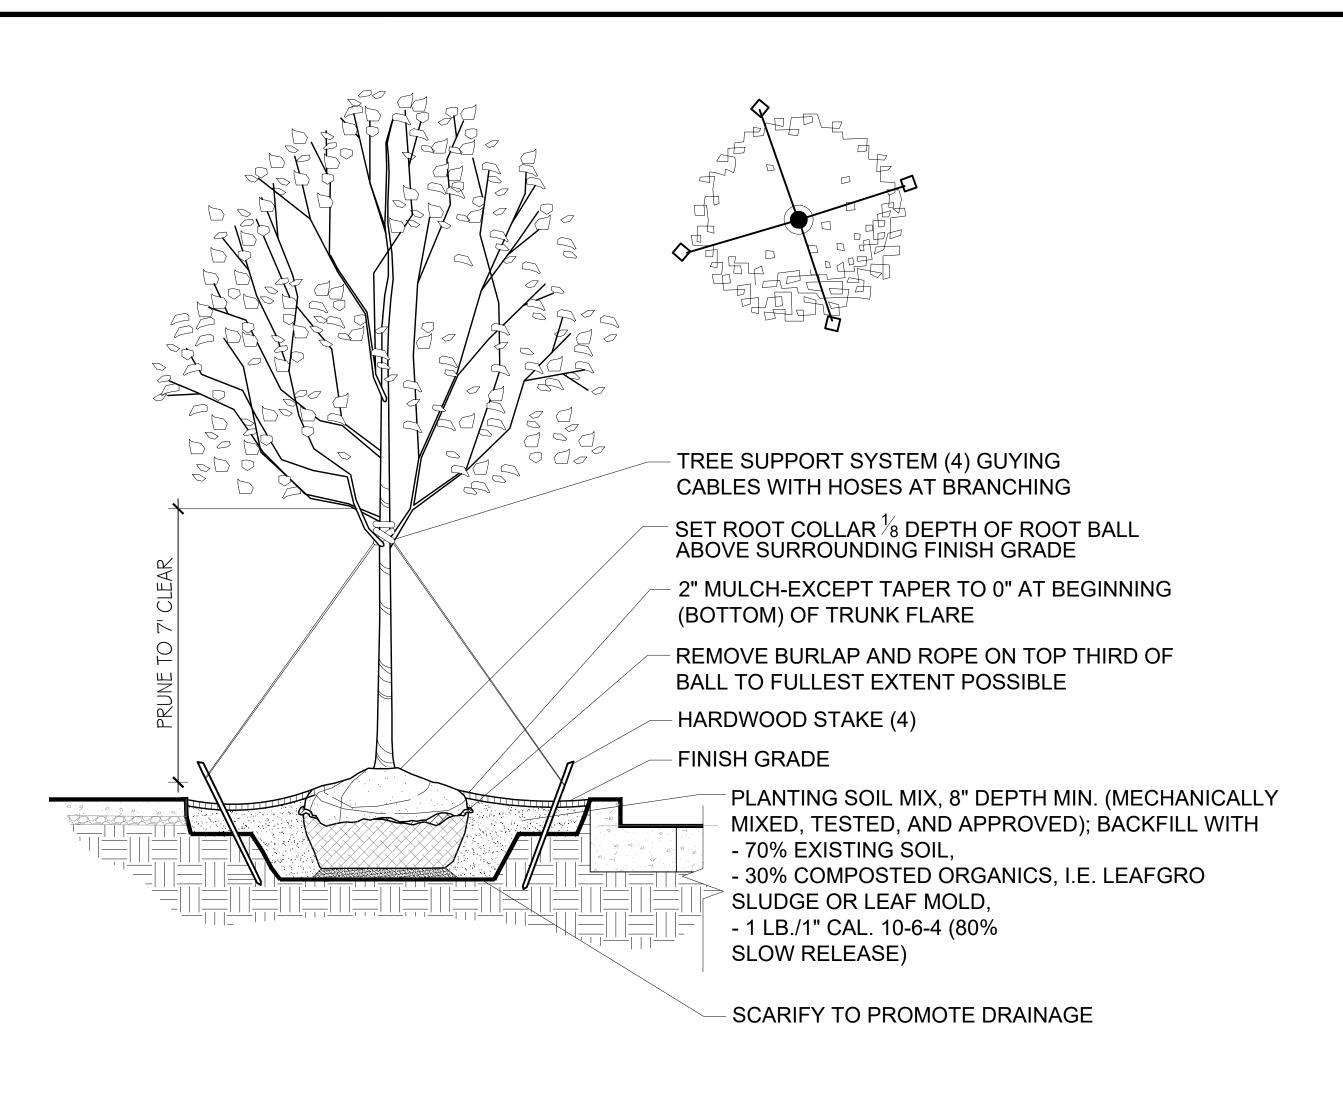



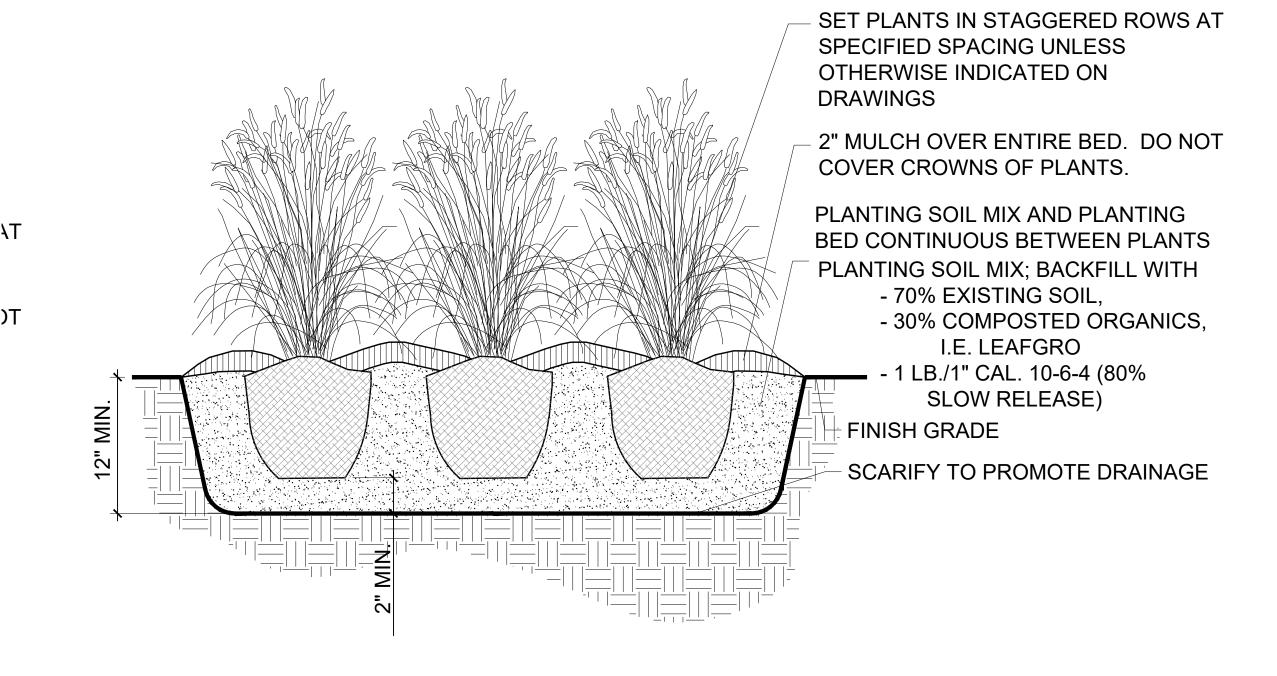

PERENNIAL PLANTING BED DETAIL SCALE: Not to Scale

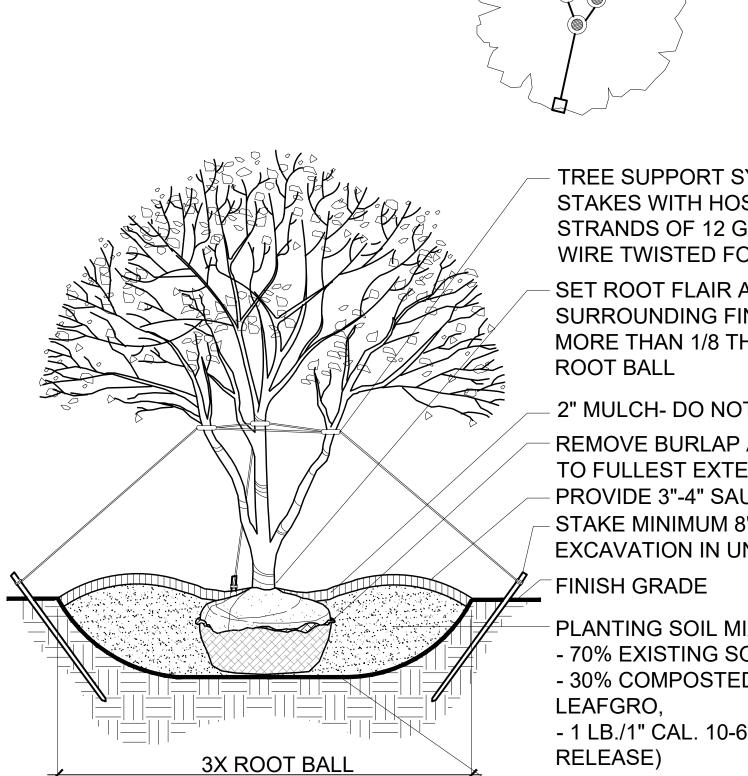

TREE SUPPORT SYSTEM (3) GUYING STAKES WITH HOSE AND TWO STRANDS OF 12 GAUGE GALVANIZED WIRE TWISTED FOR SUPPORT. SET ROOT FLAIR ABOVE SURROUNDING FINISH GRADE NO MORE THAN 1/8 THE DEPTH OF THE 2" MULCH- DO NOT COVER TRUNK FLAIR REMOVE BURLAP AND WIRE BASKET TO FULLEST EXTENT POSSIBLE

PROVIDE 3"-4" SAUCER - STAKE MINIMUM 8" BEYOND **EXCAVATION IN UNDISTURBED SOIL** PLANTING SOIL MIX; BACKFILL WITH - 70% EXISTING SOIL, - 30% COMPOSTED ORGANICS, I.E.

- 1 LB./1" CAL. 10-6-4 (80% SLOW

SCARIFY TO PROMOTE DRAINAGE

MULTI-STEM TREE PLANTING DETAIL SCALE: Not to Scale

SPECIFICATIONS FOR PLANTING:

1. CONTRACTOR IS RESPONSIBLE FOR LOCATING ALL SITE UTILITIES.

2. CONTRACTOR SHALL OBTAIN LANDSCAPE ARCHITECT'S APPROVAL OF ALL STAKED OUT LAYOUT BEFORE PROCEEDING WITH CONSTRUCTION.

3. NO PLANT MATERIAL SHALL BE PUT INTO THE GROUND BEFORE FINISHED GRADE AND BED PREP AERATION HAVE BEEN APPROVED BY THE LANDSCAPE ARCHITECT

4. THE CONTRACTOR SHALL PROCEED WITH LANDSCAPE INSTALLATION IN ACCORDANCE WITH THE REQUIREMENTS OF THE CURRENT EDITION OF THE "LANDSCAPE SPECIFICATION GUIDELINES", LANDSCAPE

CONTRACTORS ASSOCIATION OF MD, DC, AND VA. TEL:301-948-0810. 5. CONTRACTOR SHALL NOTIFY THE LANDSCAPE ARCHITECT OF ANY PROPOSED PLANT SUBSTITUTIONS AND ALL PLANT SUBSTITUTIONS SHALL BE APPROVED AND DOCUMENTED WITH WRITTEN APPROVAL OF THE OWNER. THE PLAN SHALL TAKE PRECEDENCE OVER THE PLANT LIST IF DISCREPANCIES OCCUR


6. ALL SHRUBS SHALL BE DENSE, HEAVY TO THE GROUND, WELL GROWN, VIGOROUS, HEALTHY AND OF GOOD COLOR. ALL PLANTS SHALL BE SOUND, FREE OF PLANT DISEASE OR INSECT ACTIVITY AND SHALL HAVE HEALTHY NORMAL ROOT SYSTEMS. ALL PLANTS SHALL BE NURSERY GROWN. PLANTS SHALL NOT BE PRUNED PRIOR TO DELIVERY. THE SHAPE OF THE PLANT IN GENERAL SHALL CONFORM TO ITS NATURAL HABIT, UNLESS OTHERWISE SPECIFIED. ALL PLANTS SHALL CONFORM TO THE BRANCHING, CALIPER, AND HEIGHT SPECIFICATIONS OF THE AMERICAN ASSOCIATION OF NURSERYMEN'S PUBLICATION ENTITLED "AMERICAN STANDARD FOR NURSERY STOCK", ANSI A60.1-1980. THE BALL SIZE SHALL CONFORM TO THE AMERICAN ASSOCIATION OF NURSERYMEN'S PUBLICATION ENTITLED "AMERICAN STANDARD FOR NURSERY STOCK", ANSI Z60.11980

7. BACKFILLING SHALL BE DONE WITH SOIL MIX, FREE OF STONES, SUBSOIL, CLAY, LUMPS, STUMPS, ROOTS, WEEDS, BERMUDA GRASS, LITTER, TOXIC SUBSTANCES, OR ANY OTHER MATERIAL WHICH MAY BE HARMFUL TO PLANT GROWTH OR HINDER GRADING, PLANTING OR MAINTENANCE OPERATIONS. SHOULD ANY UNFORESEEN OR UNSUITABLE PLANTING CONDITIONS ARISE SUCH AS FAULTY SOIL DRAINAGE OR CHEMICAL RESIDUES, THEY SHOULD BE CALLED TO THE ATTENTION OF THE OWNER FOR ADJUSTMENTS BEFORE PLANTING. THE PLANT SHALL BE SET PLUMB AND STRAIGHT AND SHALL BE STAKED AT THE TIME OF PLANTING. BACK-FILL SHALL BE WELL WORKED ABOUT THE ROOTS AND SETTLED IN BY WATERING. PLANTS SHALL BE PLANTED HIGHER THAN SURROUNDING GRADE. SHRUBS WILL BE 1 INCH HIGHER AND TREES WILL BE 3 INCHES HIGHER. REMOVE ROPE FROM AROUND TREE TRUNKS AND LAY BACK BURLAP FROM TOP OF B&B MATERIAL. NON BIODEGRADABLE MATERIALS SUCH AS; NYLON OR VINYL ROPE, WIRE BASKETS, TREATED BURLAP AND TREATED ROPE SHALL BE COMPLETELY REMOVED FROM ALL PLANT MATERIAL PRIOR TO PLANTING.

8. CONTRACTOR SHALL BE RESPONSIBLE DURING THE CONTRACT AND UP TO THE TIME OF ACCEPTANCE FOR KEEPING THE PLANTING AND WORK INCIDENTAL THERETO IN GOOD CONDITION BY REPLANTING, PLANT REPLACEMENT, WATERING, WEEDING, CULTIVATING, PRUNING AND SPRAYING, STAKING, CLEANING UP AND BY PERFORMING ALL OTHER NECESSARY OPERATIONS OF CARE FOR PROMOTION OF GOOD PLANT GROWTH, SO THAT ALL WORK IS IN SATISFACTORY CONDITION AT THE TIME OF ACCEPTANCE, AT NO ADDITIONAL COST TO THE OWNER.

- 2" MULCH, FORM INTO SAUCER AROUND EACH PLANT - PLANTING SOIL MIX AND PLANTING BED CONTINUOUS BETWEEN PLANTS - PLANTING SOIL MIX; BACKFILL WITH - 70% EXISTING SOIL, - 30% COMPOSTED ORGANICS, I.E. LEAFGRO - 1 LB./1" CAL. 10-6-4 (80% SLOW RELEASE) FINISH GRADE SCARIFY TO PROMOTE DRAINAGE

SHRUB PLANTING DETAIL

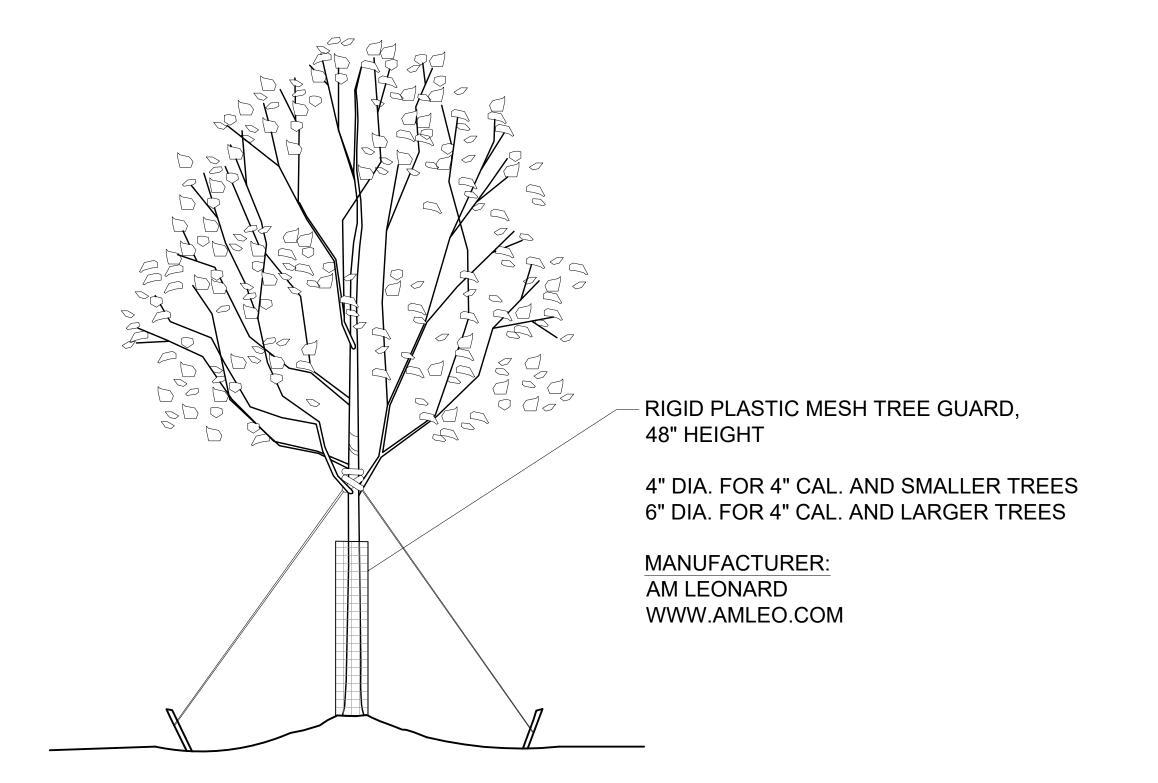


TREE GUARD SCALE: Not to Scale







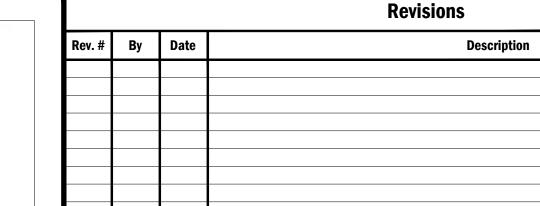












SOUTH BEACH RESTORATION TAX ID: 03-000-29043249 TAX MAP 41, GRID 21, PARCEL 98 1100 E. COLLEGE PARKWAY ANNAPOLIS, MARYLAND 21409

THIRD DISTRICT ANNE ARUNDEL COUNTY ZONED OS

Job Number 23-001 / 21-8065 Folder Reference SANDY POINT STATE PARK SOUTH BEACH RESTORATION Sheet No. L-11

**ARCHITECTS** email: info@bayengineering.com www.bayengineering.com Copyright © 2021 Warning: This document is an instrument of professional service prepared by y Engineering Inc. Alteration of this document by any party other than Bay tights Reserved. Engineering Inc. is a violation of law that will be prosecuted to its fullest ex

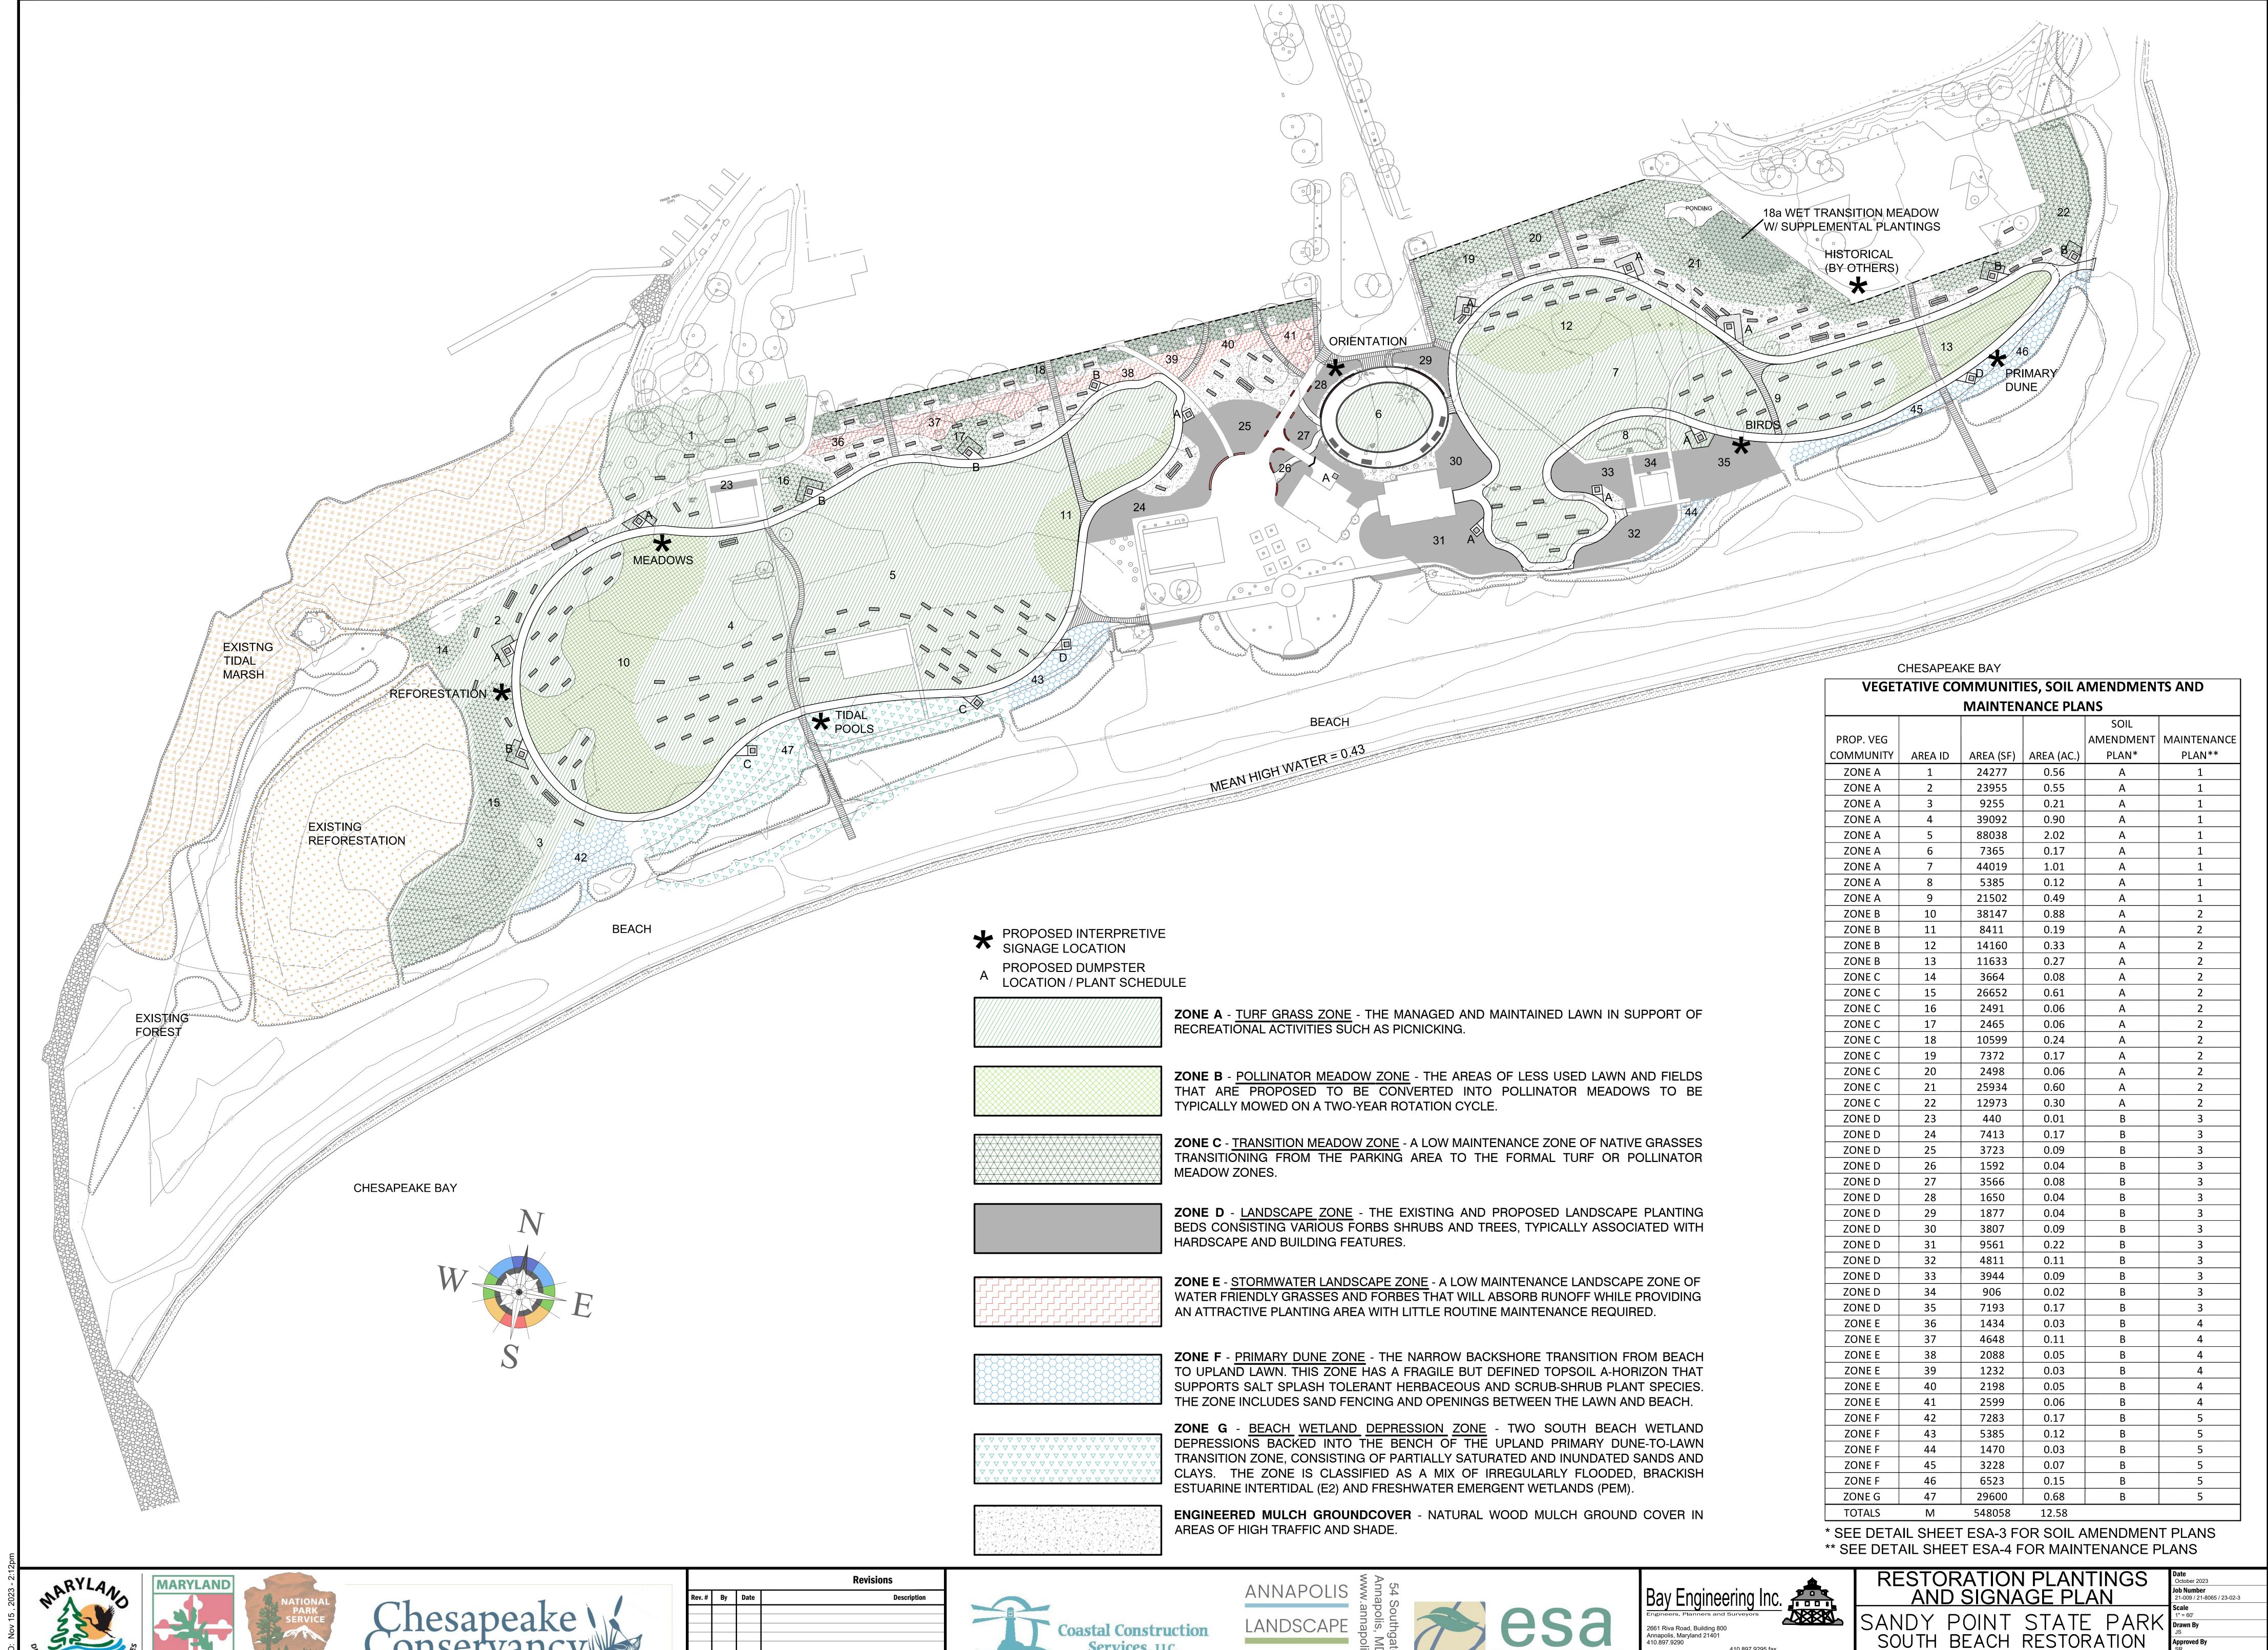

Services, LLC.

Preserving Our Waterways

**ARCHITECTS** 

email: info@bayengineering.com

Copyright © 2021 Warning: This document is an instrument of professional service prepared by ay Engineering Inc. Alteration of this document by any party other than Bay

www.bayengineering.com

**Folder Reference** SANDY POINT STATE PARK SOUTH BEACH RESTORATION Sheet No. ESA-1

TAX MAP 41, GRID 21, PARCEL 98

1100 E. COLLEGE PARKWAY

ANNAPOLIS, MARYLAND 21409

THIRD DISTRICT ANNE ARUNDEL COUNTY ZONED OS